TWINBROCKHINES

LEVEL 2 SITE PLAN APPLICATION

DEVELOPMENT TABULATIONS

Parcel Information	SF	ACRES	
Zoning	MXTD & PD-TC		
Lot Reference: Lots 2,3,4,5,6 Halpin Block 4			
Existing 1800 Chapman Property	45,797	1.05	
Proposed Dedications			
Thompson Avenue	428	0.01	
Chapman Avenue	3,382	0.08	
Future Dedication not part of 1800 Chapman Limits	96	0.00	
WMATA Property Encroachment	135	0.00	

WMATA property area to be consolidated with 1800		
Chapman property after Thompson Ave dedication	51,683	1.19
Proposed Lot Area [1]	97,480	2.24
[1] Existing lot area includes a portion of a larger WMATA	property.The remain	ainder of

the WMATA property is not included in the application.

Proposed Development	Proposed
Site Area	2.24 ac
Market Rate Units	371
MPDU 15%	66
Total Residential Units	437
Non-Residential Use	
Retail	5,075

Maximum Allowed	Proposed
120'	120'
Required	Proposed
15%	15%
14,622	14,800
	Allowed 120' Required 15%

Setbacks Sec. 25.13.05	Minimum Reauired	Minimum Proposed	
Front Yards (abutting public R/W or other lot line)	0'	0'	
Side/Rear Yards (abutting non-residential property)	0'	0'	


Parking 25.16.03	Rate	Metric	Count	Code Requirement	Parking Req'd with 28% waiver	Total Provided **
437 Multi-family units*	1.0/ 1.5*	unit	437	524	378	411
Retail	1 per 200	square feet	5075	26	20	26
Total				550	398	437

* Studio and 1 bedroom require 1.0 space per dwelling unit. Two or more bedrooms require 1.5 spaces per dwelling unit. Current unit mix to calculate parking is approximately 48 studio, 217 1 bedroom, 157 2 bedroom and 15 3 bedroom.

** Total provided parking includes 10 EV Charging Station spaces, 24 EV Ready spaces and 9 accessible spaces.

Bicycle Parking Sec. 25.16.03	Minimum Required	Provided
Bicycle Spaces		
Multi-Family Residential		
Short Term @ 1/50 du	9	13
Long Term @ 1/3 du	146	146
Retail		
Short Term@2/5000 SF	3	4
Long Term @2/12000 SF	1	1
Short Term Total	12	17
Long Term Total	147	147

ADA Parking (ADA spaces included in total above)	Total Parking Provided	Minimum Required	Provided
Multi-Family Residential & Retail	437	9	9

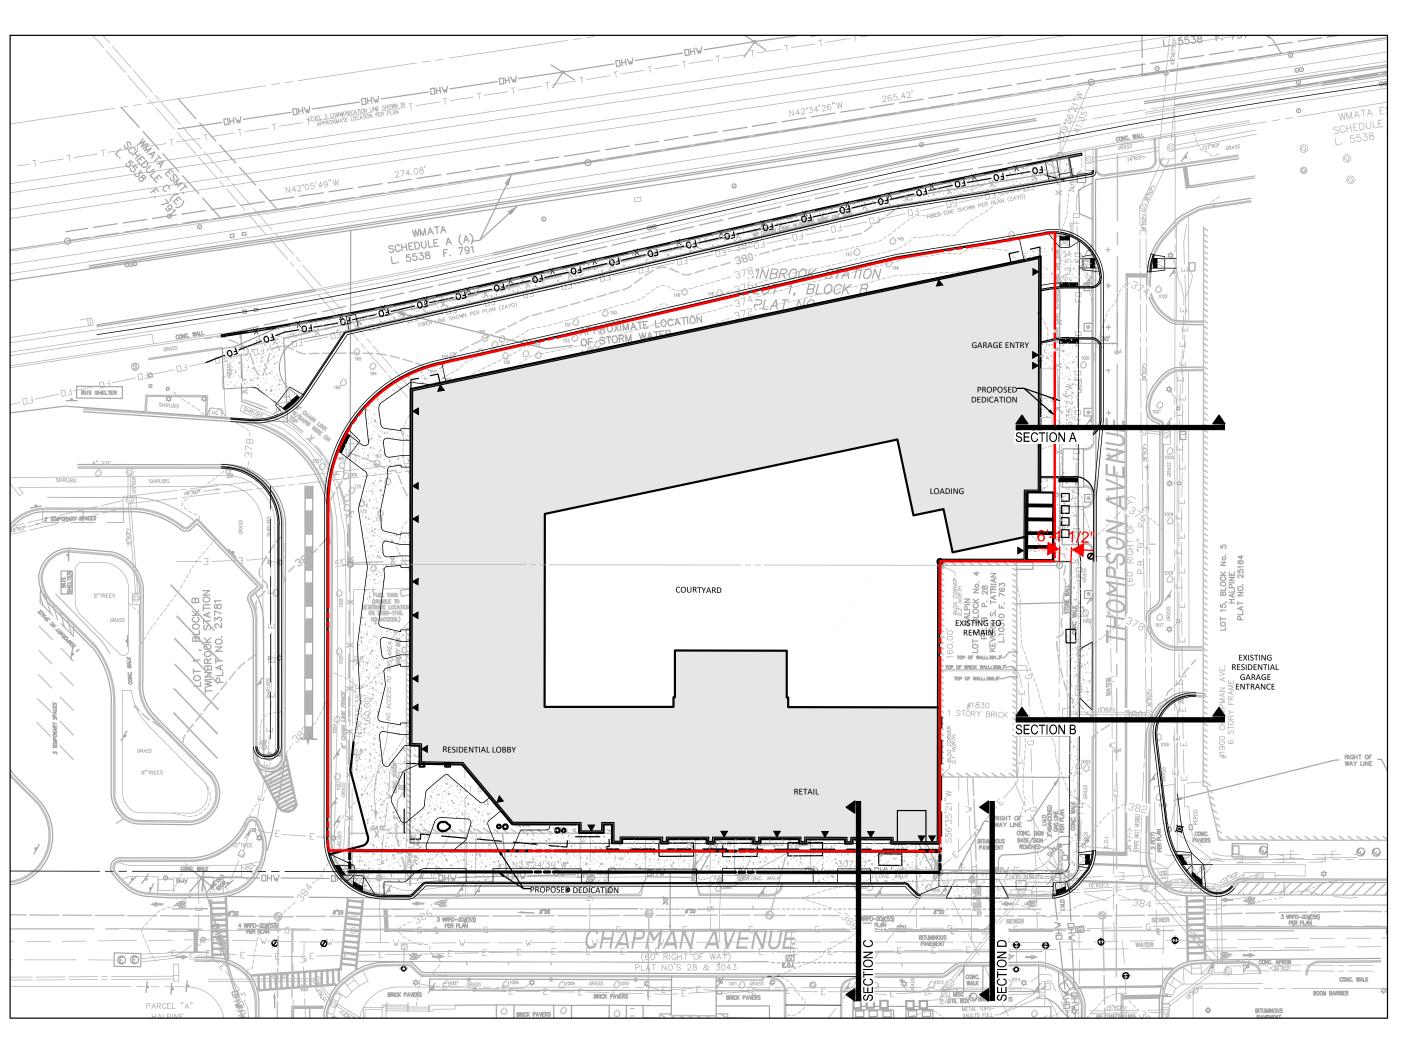

SHEET INDEX

SP-3	LEVEL 2 SITE PLAN
SP-4	LEVEL 2 OPEN SPACE SITE PLAN
_	
SP-5	LEVEL 2 BUS CIRCULATION PLAN
SP-6	FIRE DEPARTMENT ACCESS PLAN
L-000	GENERAL NOTES
L-101	LANDSCAPE MATERIALS PLAN - STREETSCAPE
L-102	LANDSCAPE MATERIALS PLAN - AMENITY DECI
L-201	SITE DETAILS
L-202	SITE DETAILS
L-203	SITE DETAILS
L-301	LANDSCAPE PLANTING PLAN
L-302	LANDSCAPE PLANTING PLAN - AMENITY DECK
L-401	PLANTING DETAILS
L-402	PLANTING DETAILS
L-501	LIGHTING PLAN
L-601	LIGHTING DETAILS
L 001	LIGHTING DETAILS

LEVEL 2 SITE PLAN COVER SHEET

LEVEL 2 EXISTING SITE PLAN

FLOOR PLAN - LEVEL P1 A.101 FLOOR PLAN - LEVEL 01 FLOOR PLAN - LEVEL 02 FLOOR PLAN - LEVEL 03 FLOOR PLAN - LEVEL 04 A.105

FLOOR PLAN - TYPICAL (LEVELS 5 - 8) FLOOR PLAN - LEVEL 09 A.109 FLOOR PLAN - LEVEL 10

ROOF PLAN MPDU FLOOR PLAN A.112 A.201 **EXTERIOR ELEVATIONS** A.202 **EXTERIOR ELEVATIONS** A.203 EXTERIOR ELEVATIONS - COURTYARD **EXTERIOR ELEVATIONS - COURTYARD**

SEDIMENT EROSION FOR DEMOLITION SEDIMENT EROSION FOR EXCAVATION SEDIMENT EROSION FOR CONSTRUCTION

CONCEPT STORMWATER MANAGEMENT COVER CONCEPT STORMWATER MANAGEMENT DRAINAGE AREA CSWM-3 DEVELOPMENT CONCEPT STORMWATER MANAGEMENT 30 SCALE DEVELOPMENT CONCEPT STORMWATER MANAGEMENT DETAILS CONCEPT STORMWATER MANAGEMENT DETAILED SECTIONS

SCALE: 1" = 50'

PAVEMENT MARKING & SIGNAGE PLAN COVER SHEET PAVEMENT MARKING & SIGNAGE PLAN PAVEMENT MARKING & SIGNAGE DETAILS

SUPPORT **AUTOTURN MOVEMENTS EXISTING DRAINAGE AREA STUDY** STORMWATER FORESTRY OVERLAY SIGHT DISTANCE STUDIES

Community Planning & **Development Services** Received 12/14/2022


GENERAL NOTES


VICINITY MAP SCALE: 1" = 2000'


- THE PROPERTY IS 2.24 ACRES.
- THE PROPERTY IS ZONED MXTD Mixed-Use Transit District **AND PD-TC, Twinbrook Commons**
- THE SITE IS LOCATED ON WSSC MAP 216NE06.
- THE SUBJECT PROPERTY IS LOCATED ON TAX ASSESSMENT MAP NO. GQ63, WITH TAX ACCOUNT NO. **04-00153095**.
- BOUNDARY AND TOPOGRAPHIC DATA UPDATE BY VIKA MARYLAND, LLC. IN 2021.
- THERE IS NO 100 YEAR FLOODPLAIN LOCATED ON THE SITE.


THERE IS NO STREAM VALLEY BUFFER LOCATED ON THE SITE.

THERE ARE NO WETLANDS LOCATED ON THE SITE.

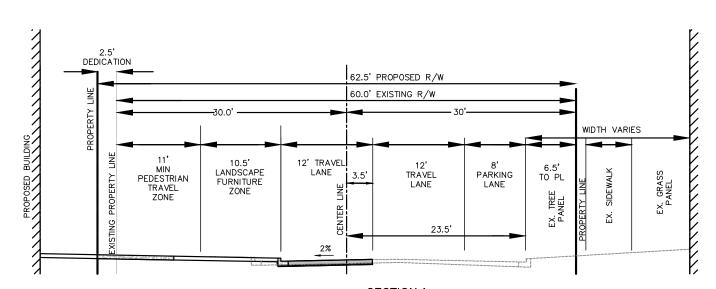

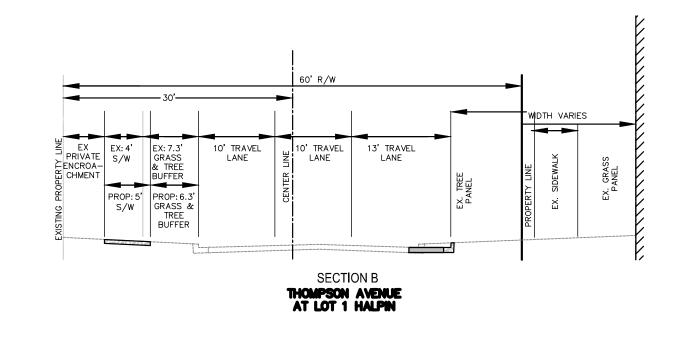

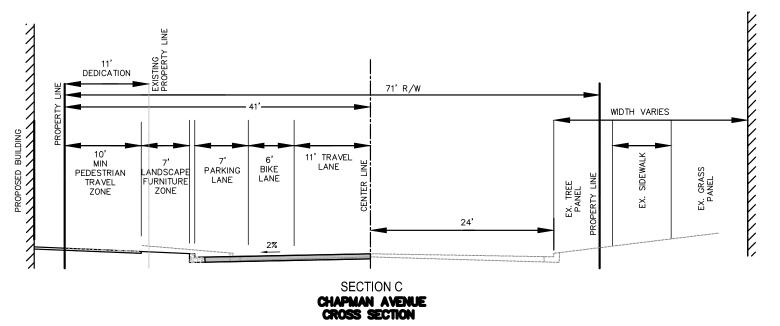

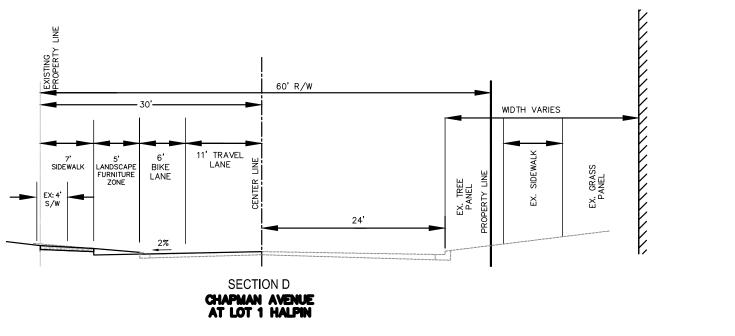

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PREPARED FOR: HINES CONCEPTUAL **CONSTRUCTION GROUP** 2800 POST OAK BOULEVARD HOUSTON, TX 77056

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CAMERON CHRISTIAN

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WELLS + ASSOCIATES 1110 BONIFANT STREET, SUITE 210 SILVER SPRING, MD 20910 CONTACT: NANCY RANDALL

LANDSCAPE ARCHITECT: **DESIGN WORKSHOP 301 NORTH WEST STREET** SUITE 109 RALEIGH, NC 27603 **CONTACT: BENJAMIN BOYD**

REVISIONS 9/30/2022

SITE PLAN APPLICATION 4TH ELECTION DISTRICT MONTGOMERY COUNTY, MARYLAND WSSC GRID: 216NW06 TAX MAP:GQ63

SITE PLAN COVER SHEET



I HEREBY CERTIFY THAT THESE DOCUMENTS WERE **DULY LICENSED PROFESSIONAL ENGINEER UNDER** THE LAWS OF THE STATE OF MARYLAND.
NAME: LAURENT G. MOUNAUD

LICENSE No.: 36749 EXPIRATION DATE: JANUARY 21, 2023 DRAWINGS OR DOCUMENTS ARE PROPRIETARY TO VIKA MARYLAND, LLC AND CONSTITUTE ITS PROPRIETARY INTELLECTUAL PROPERTY. THESE DRAWINGS AND/OR DOCUMENTS MUST NOT BE FORWARDED, SHARED, COPIED. DIGITALLY CONVERTED. MODIFIED OR USED WRITTEN AUTHORIZATION FROM VIKA MARYLAND, LL VIOLATIONS MAY RESULT IN PROSECUTION. ONLY APPROVED, SIGNED AND SEALED PLANS OR DRAWINGS


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PROJECT DRAWING SP-1

SHEET NO.

"FOR LOCATION OF UTILITIES CALL 8-1-1 or 1-800-257-7777 OR LOG ON TO www.call811.com or http://www.missutility.ne 48 HOURS IN ADVANCE OF ANY WORK IN THIS VICINITY" The excavator must notify all public utility companies with underground facilities in the area of proposed excavation and have those facilities located by the utility companies prior to commencing excavation. The excavator is responsible for compliance with requirements of Chapter 36A of the Montgomery County Code.



VIKA MARYLAND, LLC
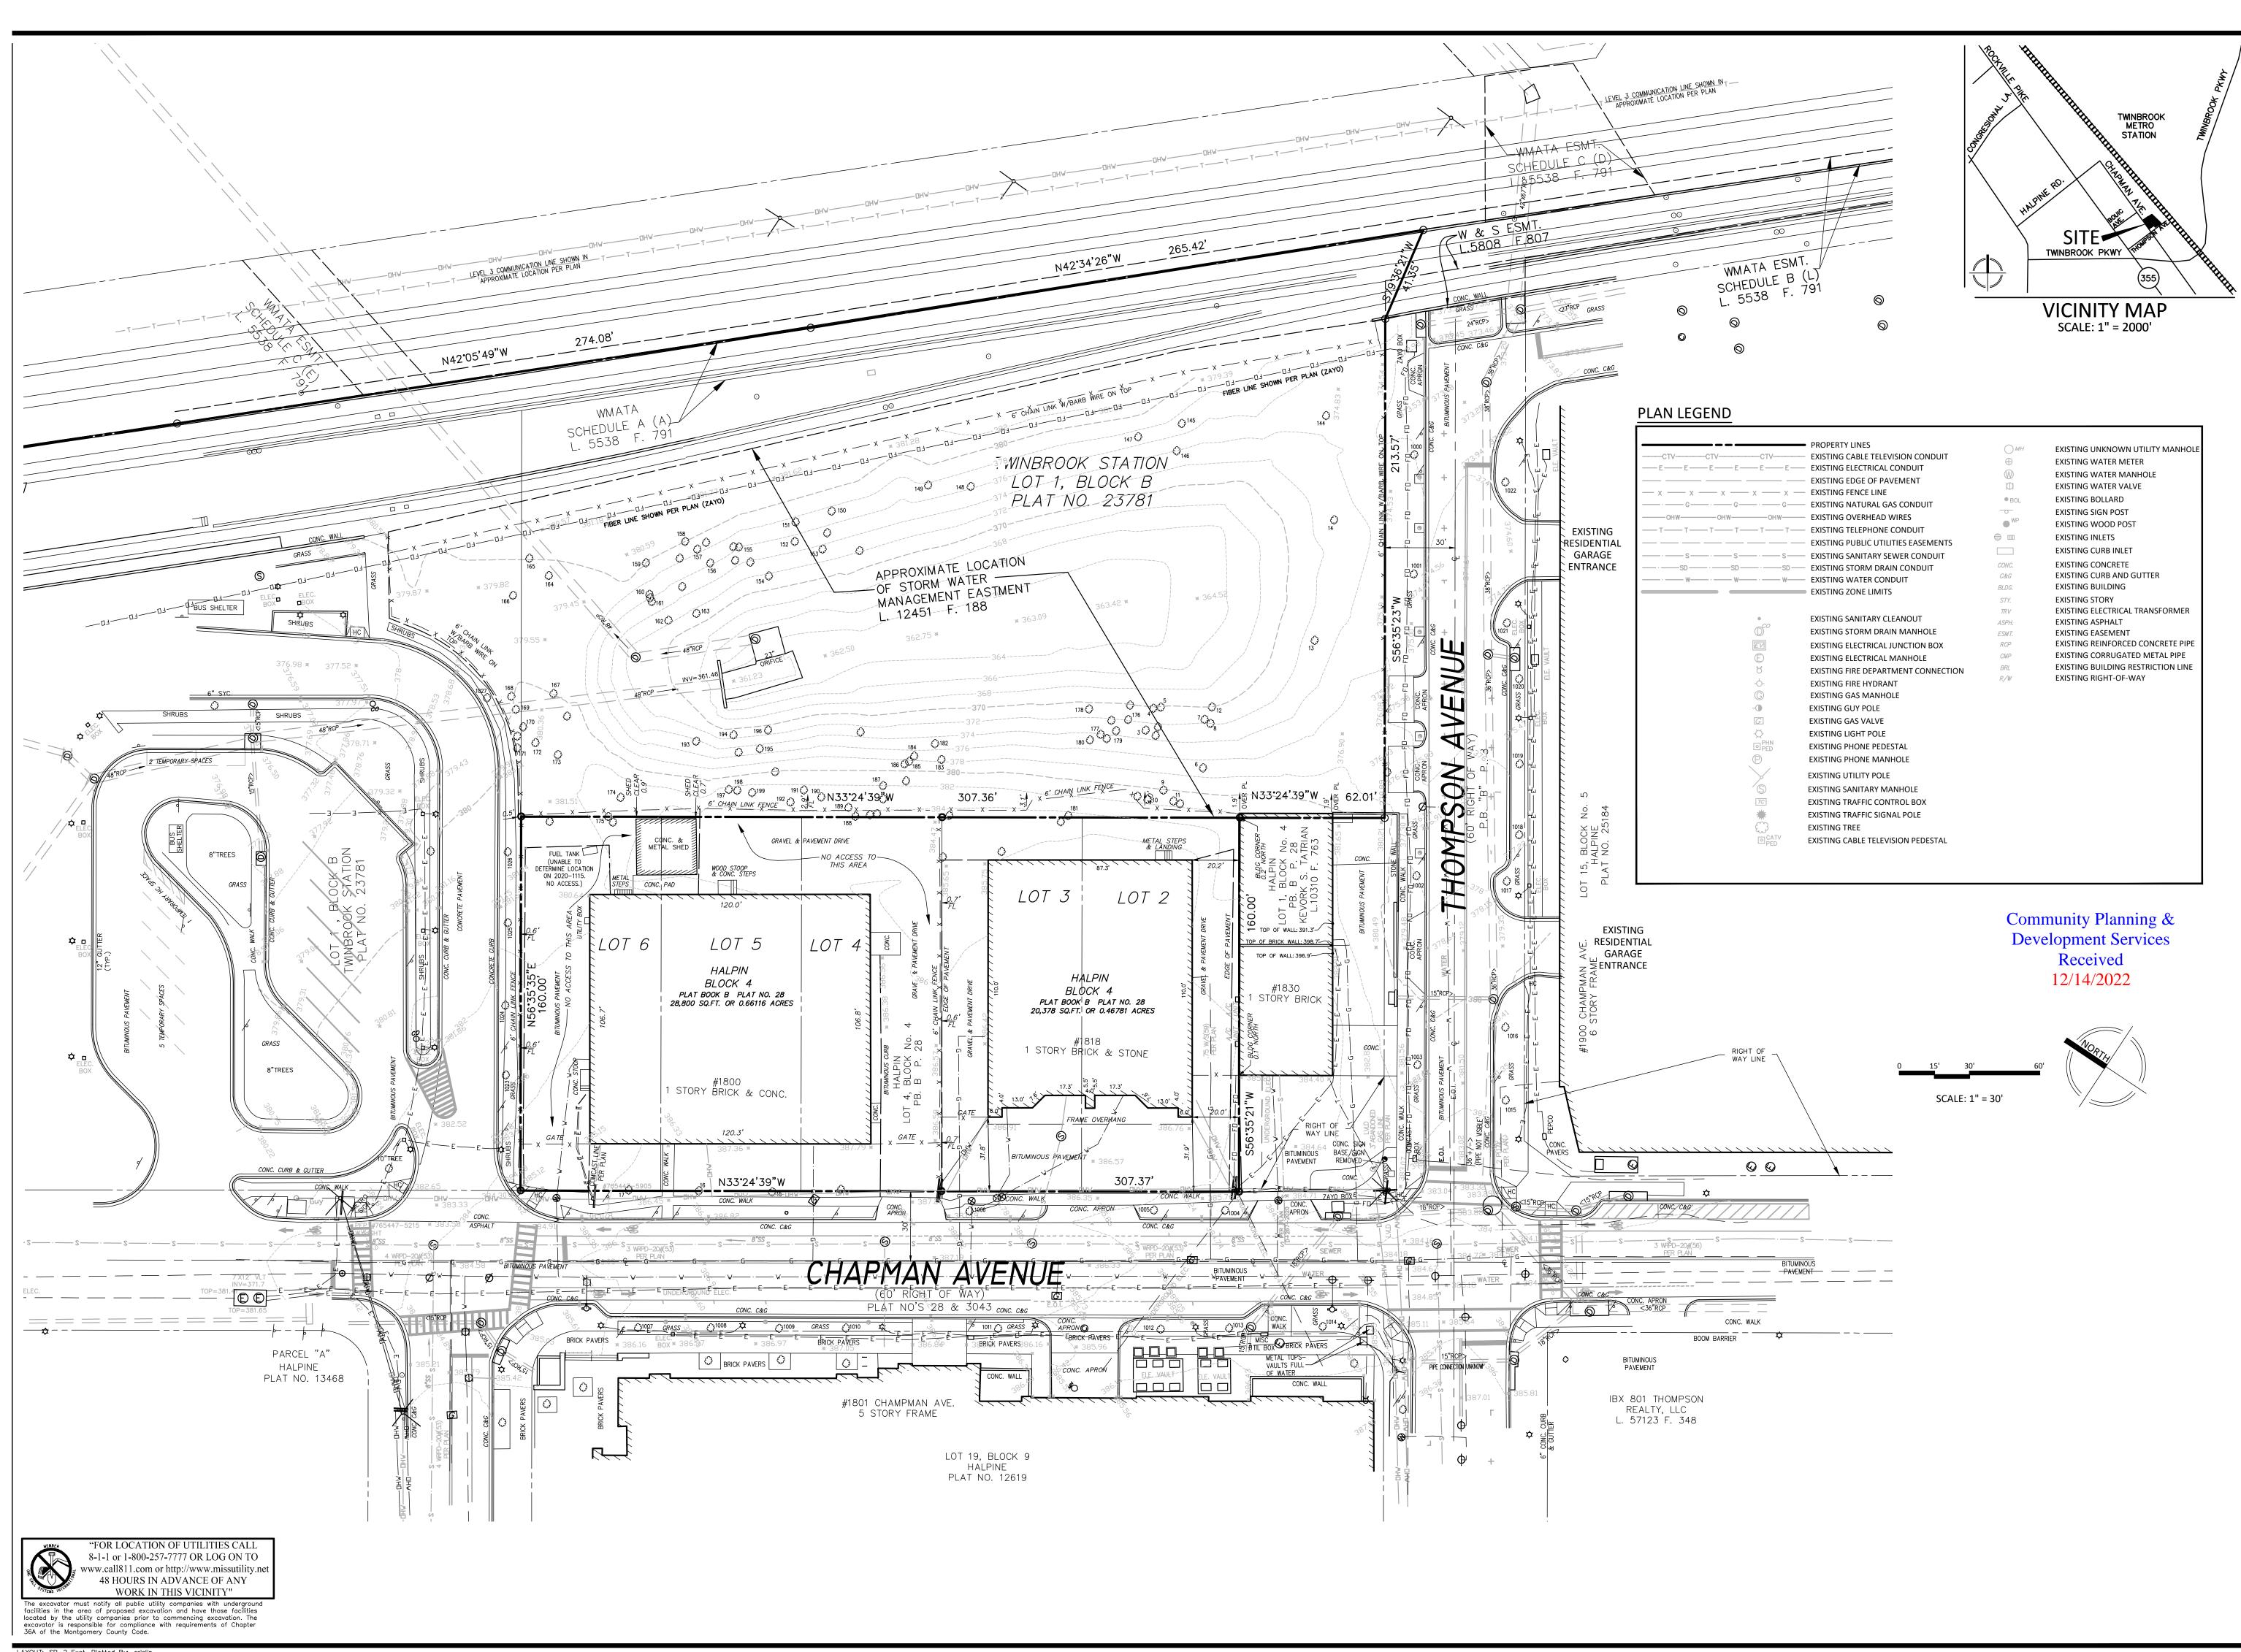
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4800 HAMPDEN LANE, SUITE 200

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TRAFFIC:
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301 NORTH WEST STREET
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919.973.6254
CONTACT: BENJAMIN BOYD

REVISIONS
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1800 CHAPMAN

SITE PLAN
APPLICATION
4TH ELECTION DISTRICT
MONTGOMERY COUNTY,
MARYLAND
WSSC GRID: 216NW06
TAX MAP:GQ63

EXISTING CONDITIONS SITE PLAN



I HEREBY CERTIFY THAT THESE DOCUMENTS WERE PREPARED OR APPROVED BY ME, AND THAT I AM A DULY LICENSED PROFESSIONAL ENGINEER UNDER THE LAWS OF THE STATE OF MARYLAND. NAME: LAURENT G. MOUNAUD LICENSE No.: 36749 EXPIRATION DATE: JANUARY 21, 2023

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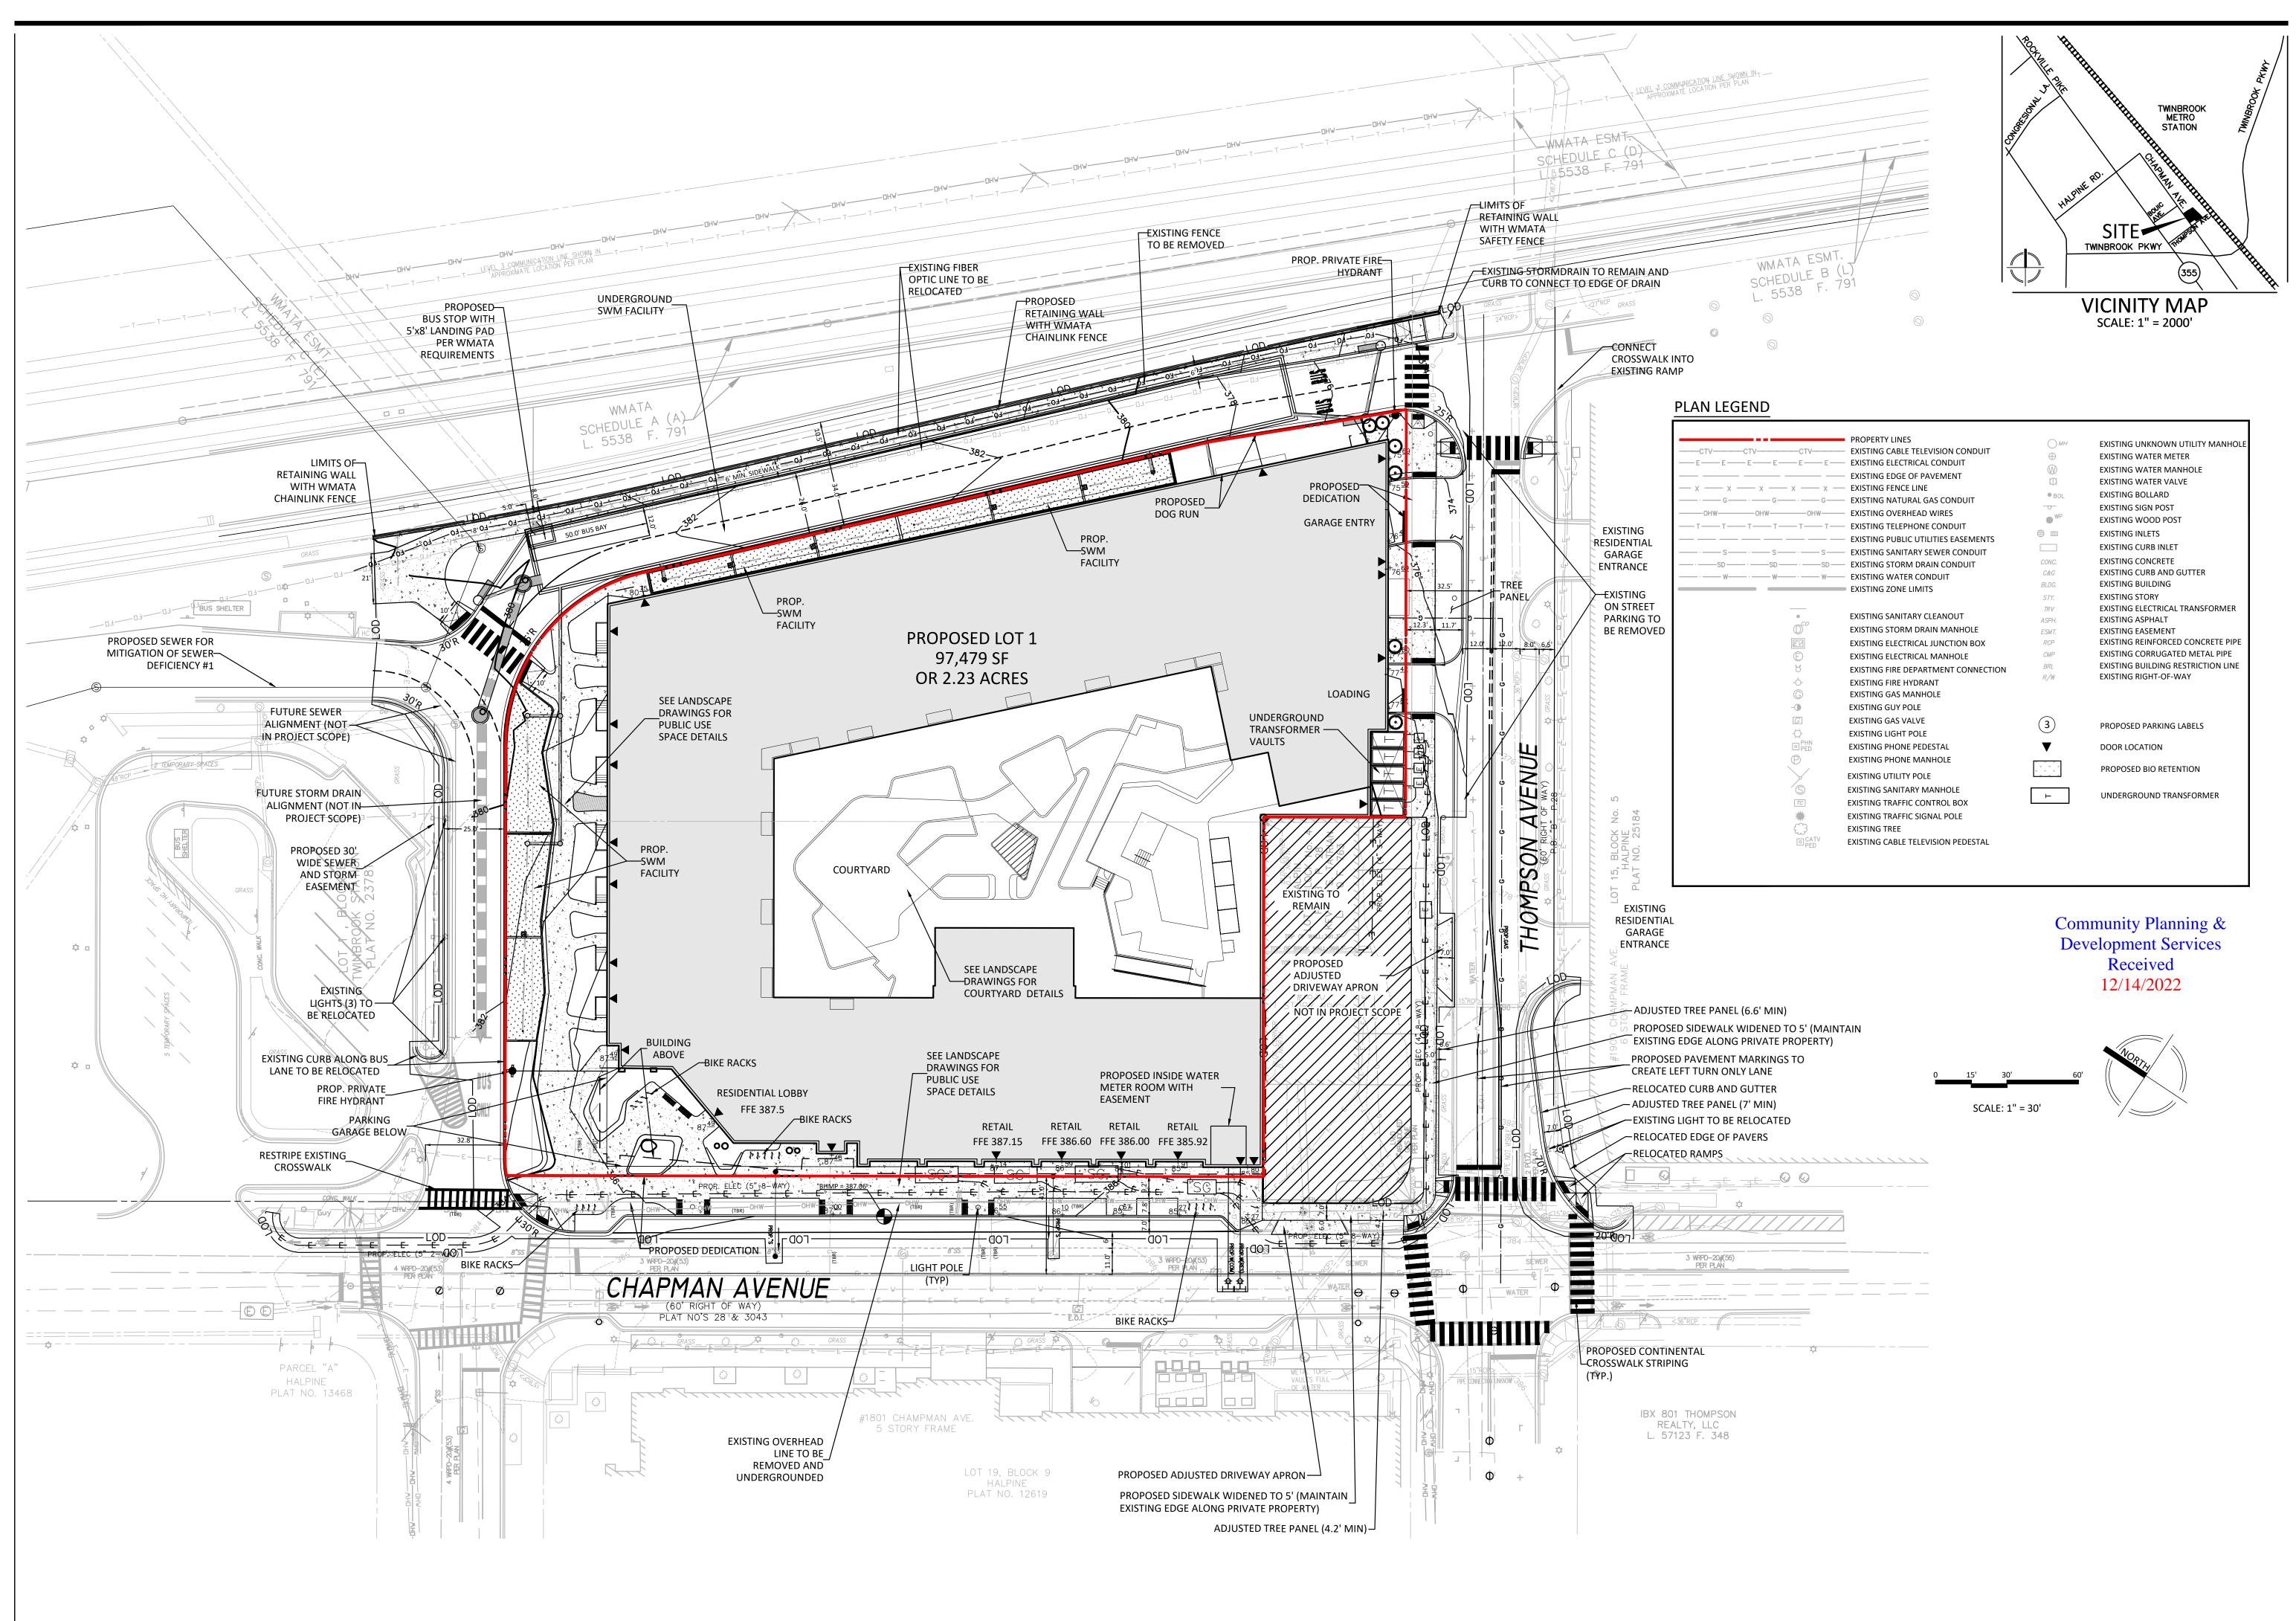
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DESIGNED BY: JAE

DATE ISSUED: 11/12/2021

PROJECT VM50024

DRAWING NO. SP-2



LAYOUT: SP-3 Plan, Plotted By: Mounaud



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CONTACT: KACEY HUNTINGTON ATTORNEY: WIRES GILL LLP 4800 HAMPDEN LANE, SUITE 200 BETHESDA, MD, 20814

301.263.6275 CONTACT: **HEATHER DLHOPOLSKY**

TRAFFIC: WELLS + ASSOCIATES 1110 BONIFANT STREET, SUITE 210 SILVER SPRING, MD 20910 301.448.1333 CONTACT: NANCY RANDALL

LANDSCAPE ARCHITECT: **DESIGN WORKSHOP** 301 NORTH WEST STREET SUITE 109 RALEIGH, NC 27603 919.973.6254 CONTACT: BENJAMIN BOYD

VISIONS	DATE
ubmission	9/30/2022
ubmission	12/08/2022

1800 **CHAPMAN**

SITE PLAN APPLICATION 4TH ELECTION DISTRICT MONTGOMERY COUNTY, MARYLAND WSSC GRID: 216NW06 TAX MAP:GQ63

LEVEL 2 SITE PLAN



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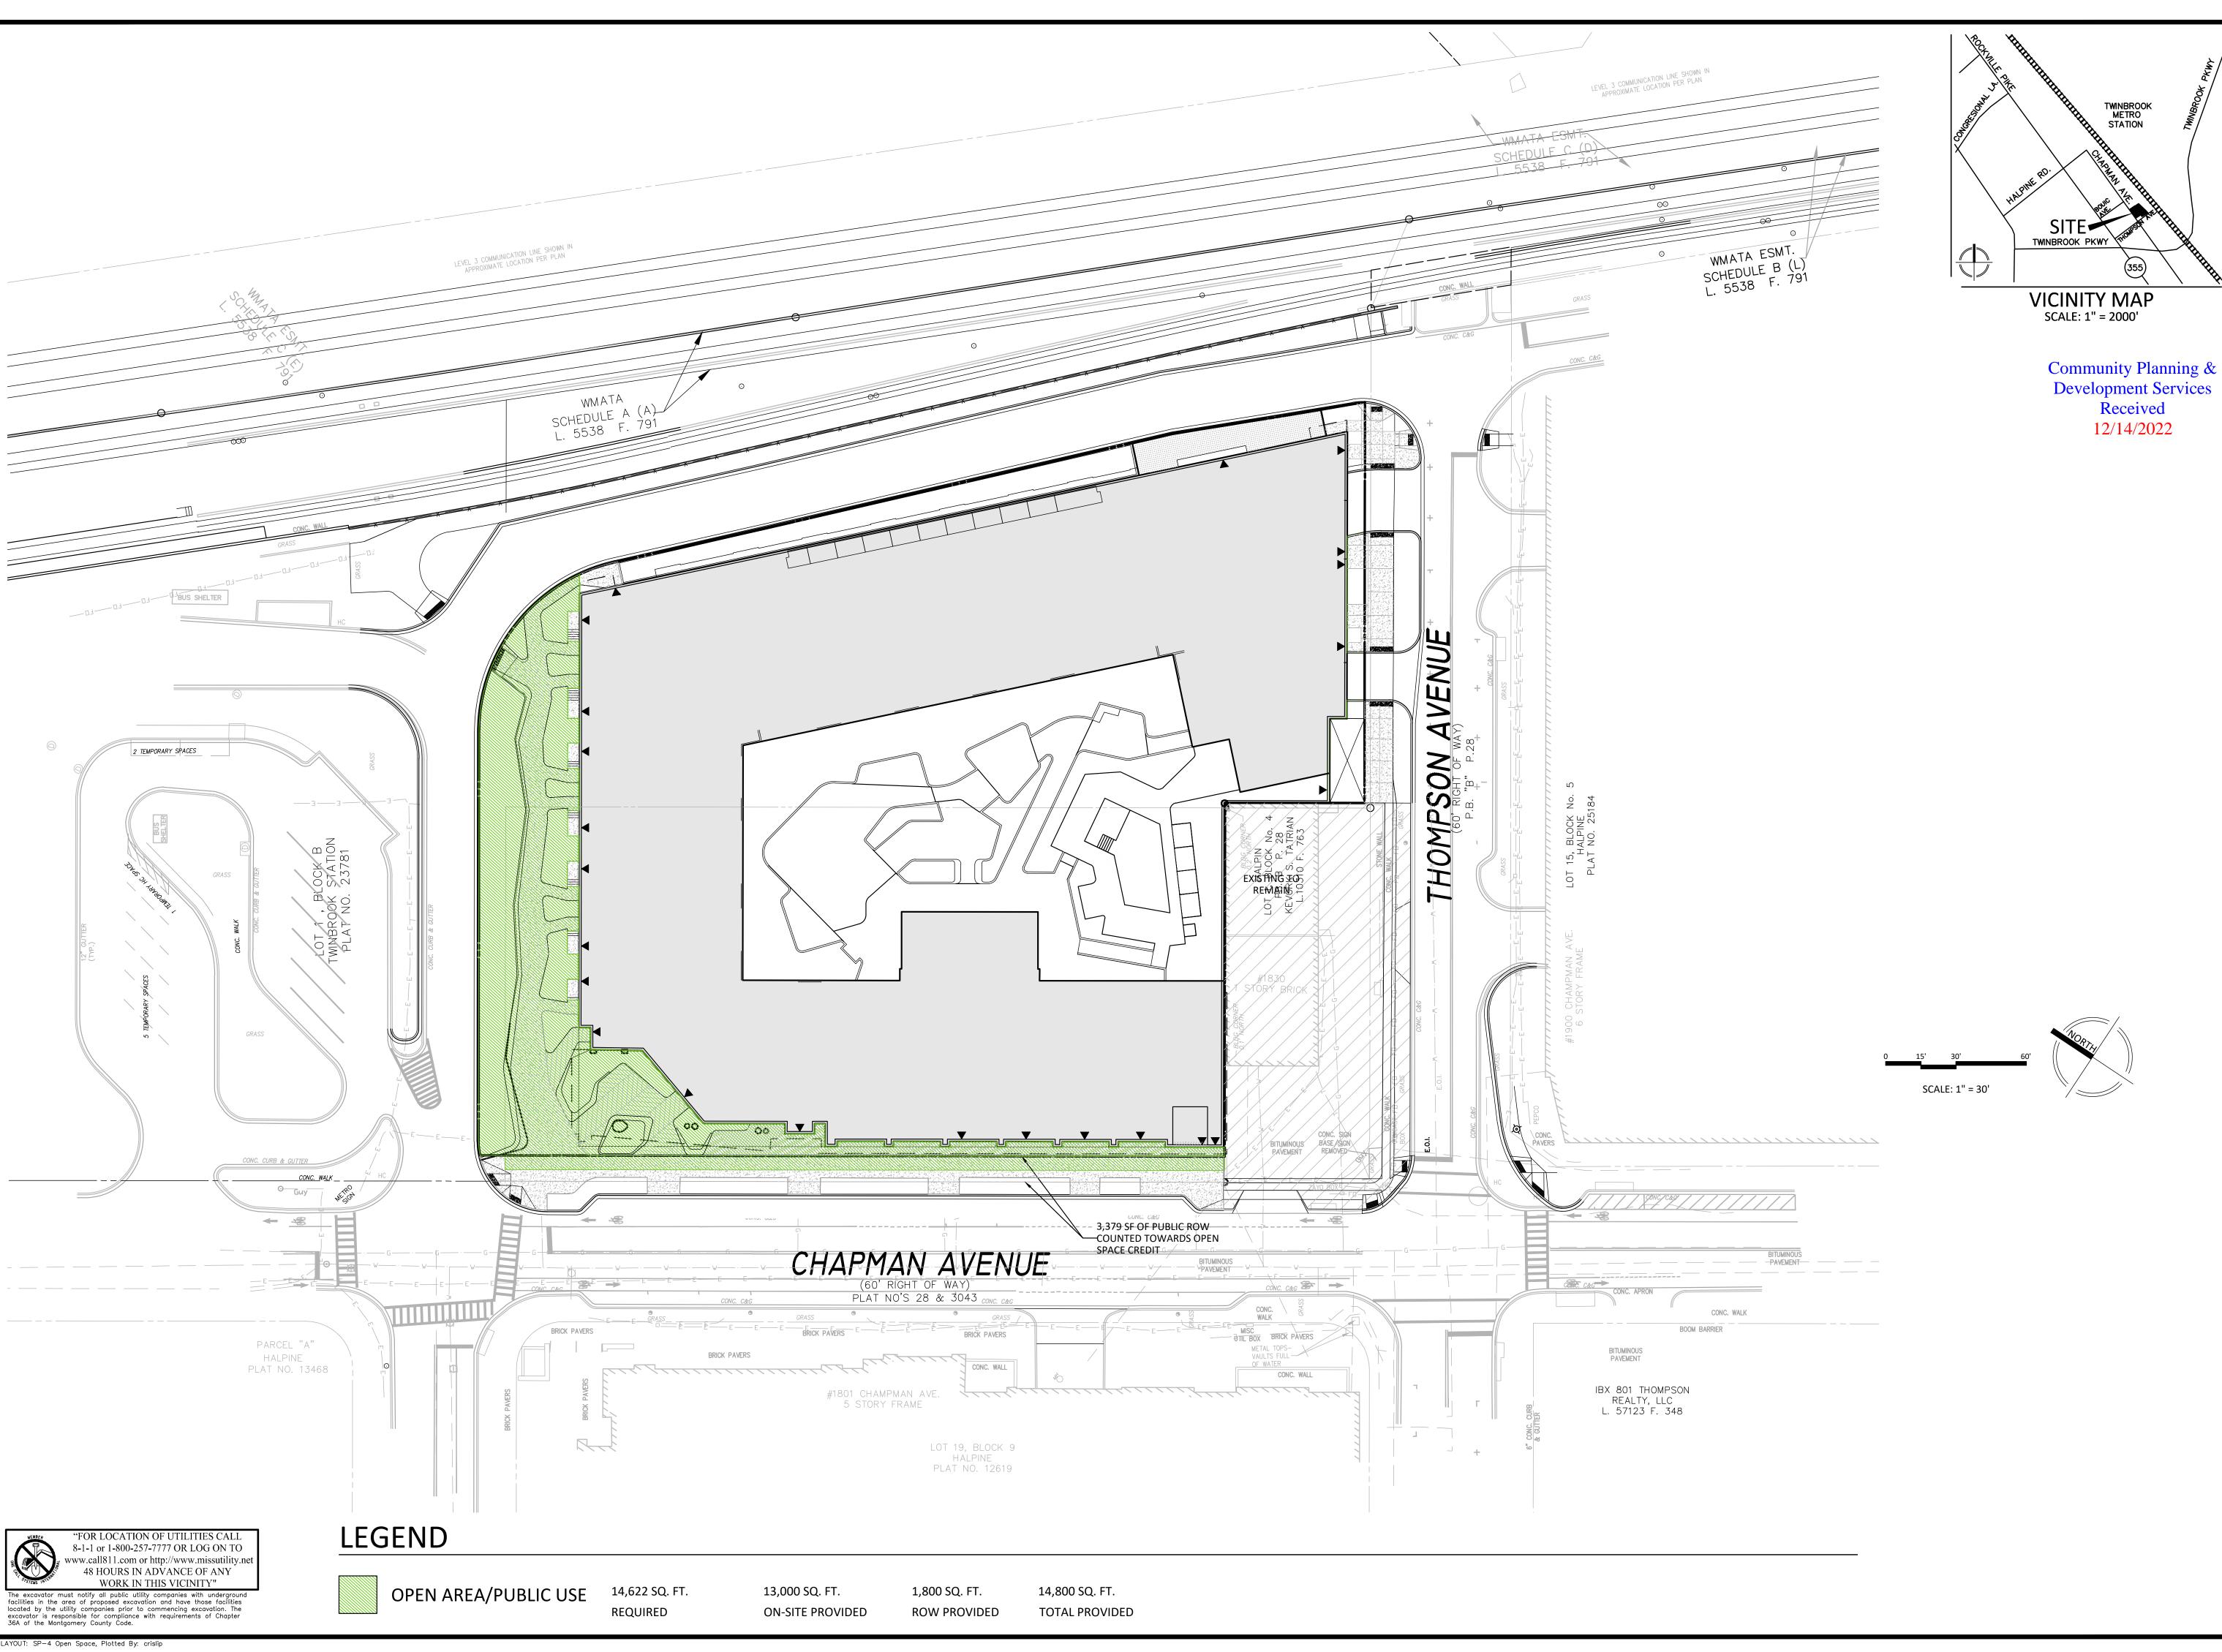
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LANDSCAPE ARCHITECT:

REVISIONS Resubmission 9/30/2022 Resubmission 12/08/2022

1800 CHAPMAN

SITE PLAN **APPLICATION** 4TH ELECTION DISTRICT MONTGOMERY COUNTY, MARYLAND WSSC GRID: 216NW06 TAX MAP:GQ63

OPEN AREA SITE PLAN




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VM50024 PROJECT DRAWING SP-4





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CAMERON CHRISTIAN

CONTACT: KACEY HUNTINGTON ATTORNEY: WIRES GILL LLP 4800 HAMPDEN LANE, SUITE 200 BETHESDA, MD, 20814 301.263.6275

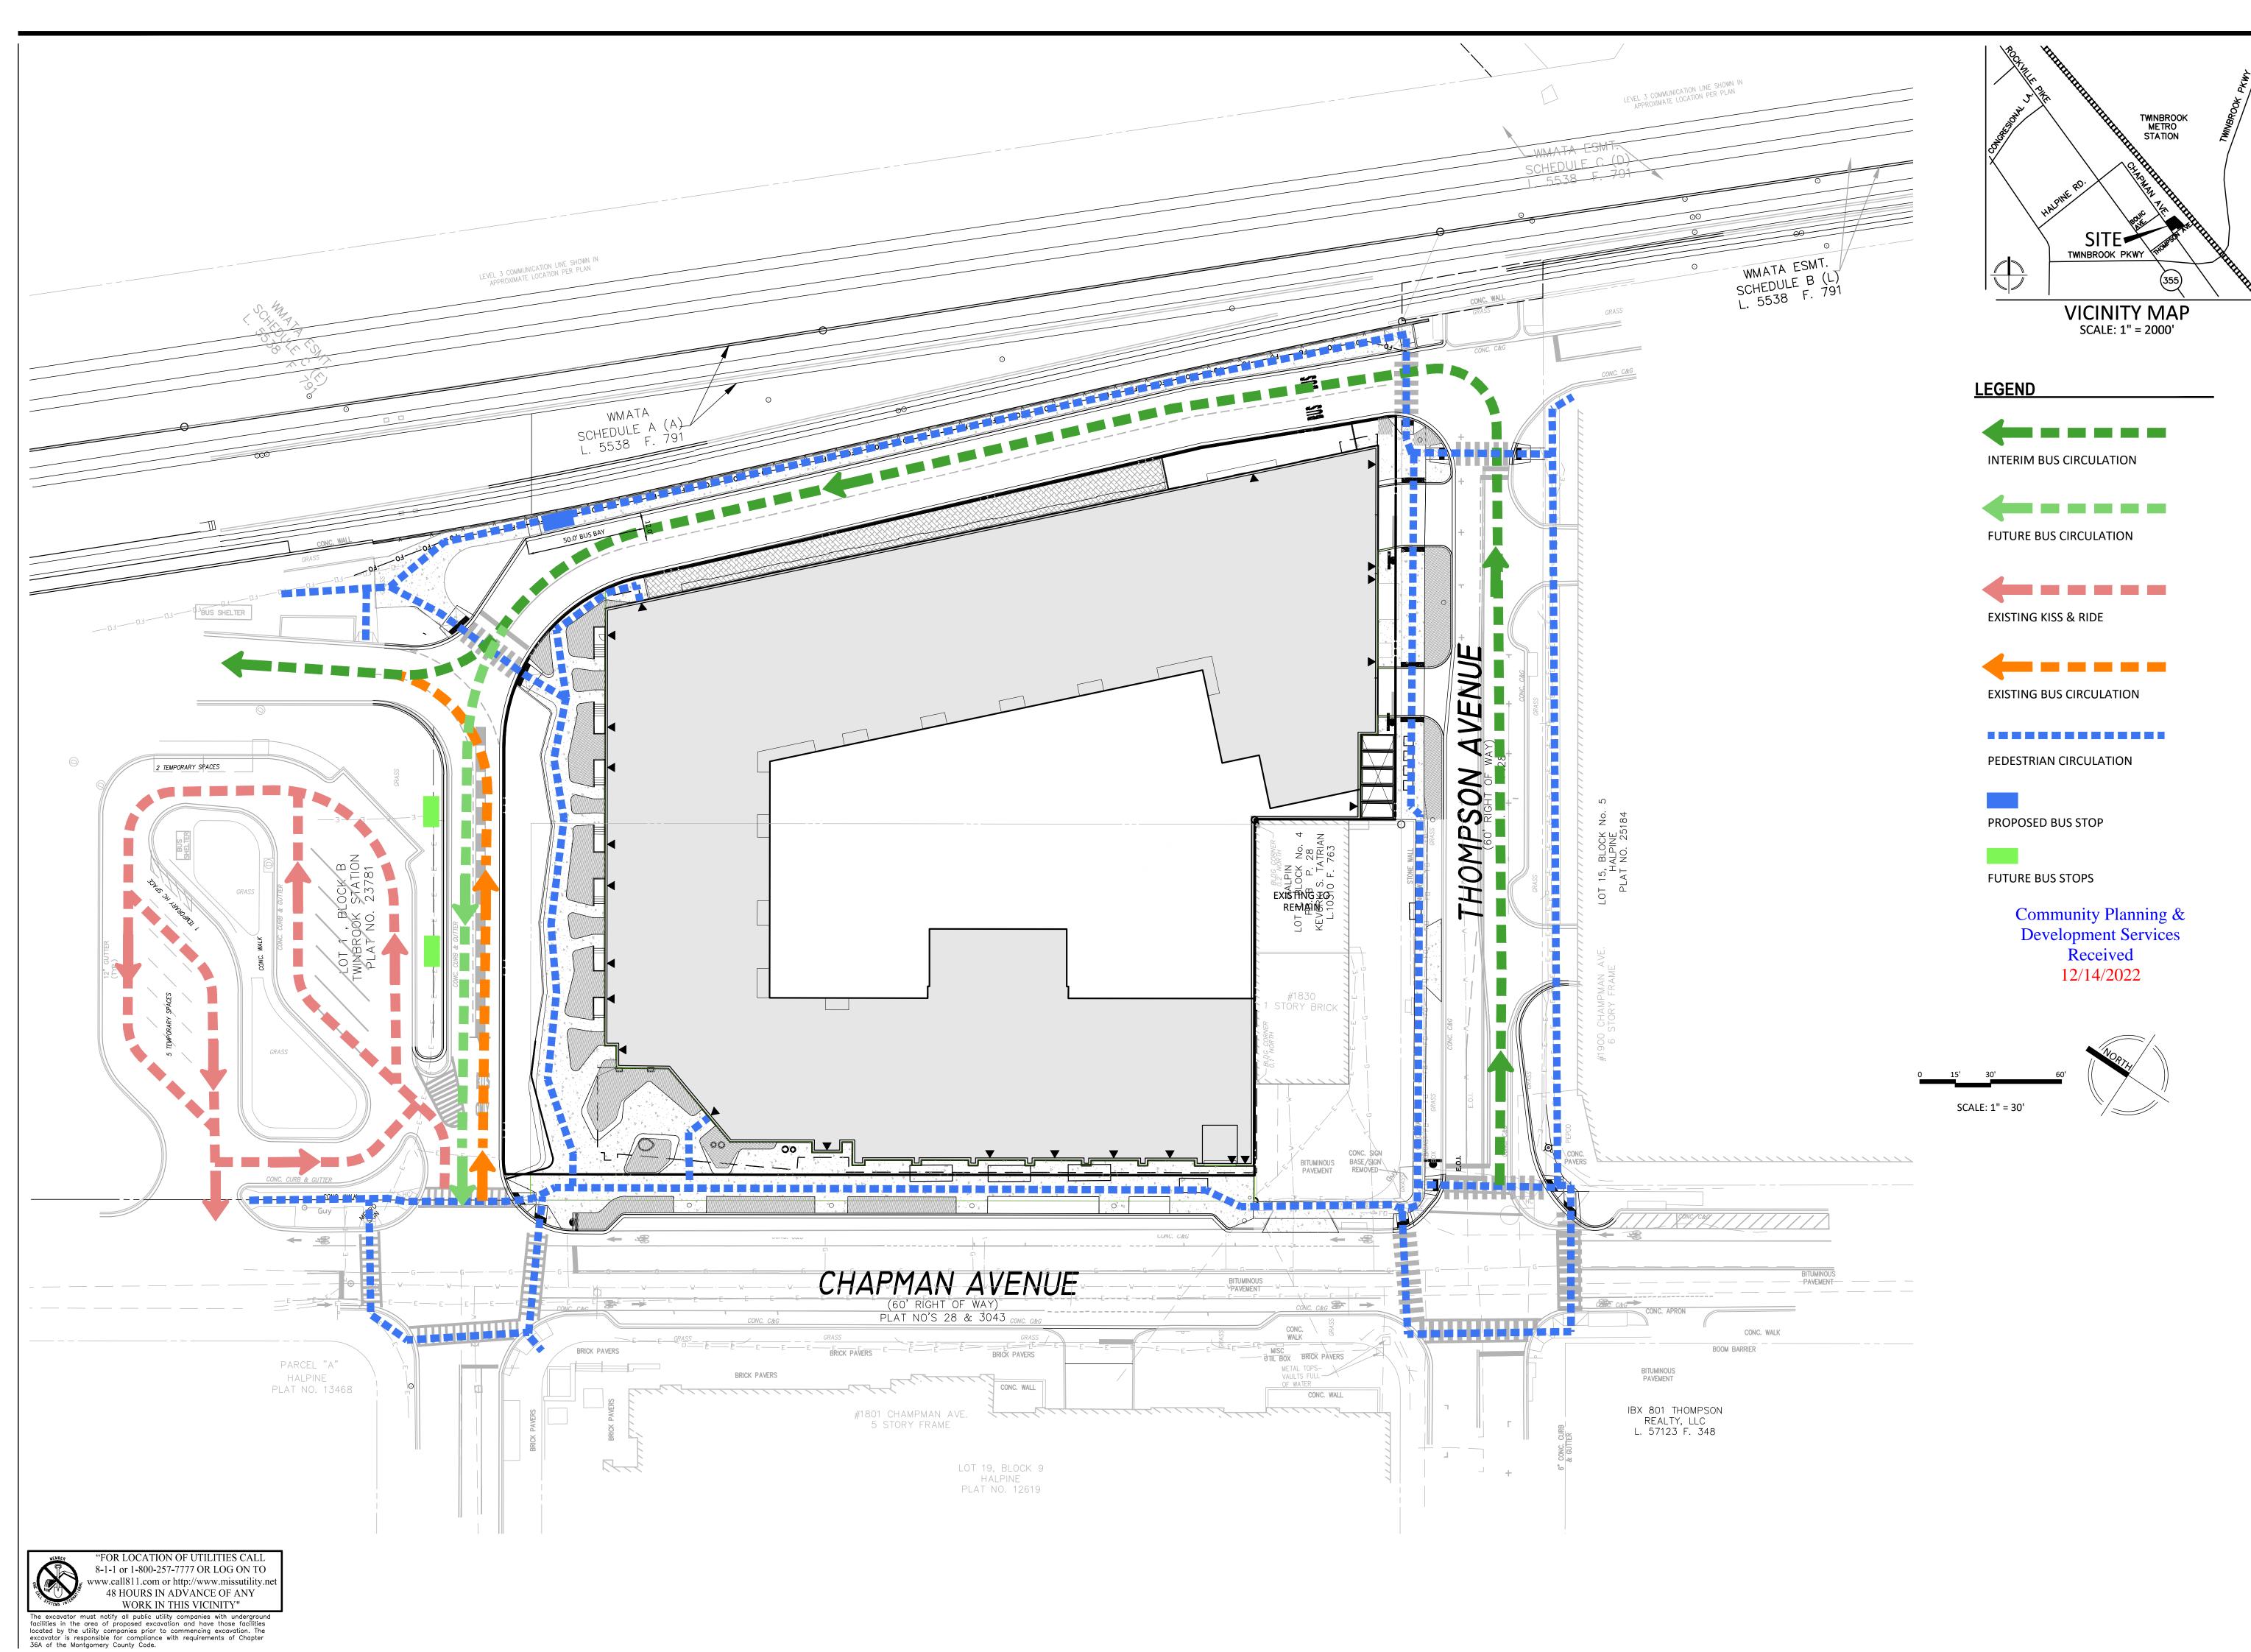CONTACT: HEATHER DLHOPOLSKY TRAFFIC:

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LANDSCAPE ARCHITECT: **DESIGN WORKSHOP** 301 NORTH WEST STREET SUITE 109 RALEIGH, NC 27603 919.973.6254 CONTACT: BENJAMIN BOYD

REVISIONS Resubmission 9/30/2022 Resubmission 12/08/2022

> 1800 CHAPMAN

SITE PLAN **APPLICATION** 4TH ELECTION DISTRICT MONTGOMERY COUNTY, MARYLAND WSSC GRID: 216NW06 TAX MAP:GQ63

BUS CIRCULATION PLAN




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NAME: LAURENT G. MOUNAUD LICENSE No.: 36749 EXPIRATION DATE: JANUARY 21, 2023


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VM50024 PROJECT DRAWING SP-5





- THE SUBJECT PROPERTY IS ZONED MXTD AS WELL AS PD-TC (WMATA PORTION - SWM FACILITY AT THE NORTH)
- THE PROPERTY IS IDENTIFIED AS:

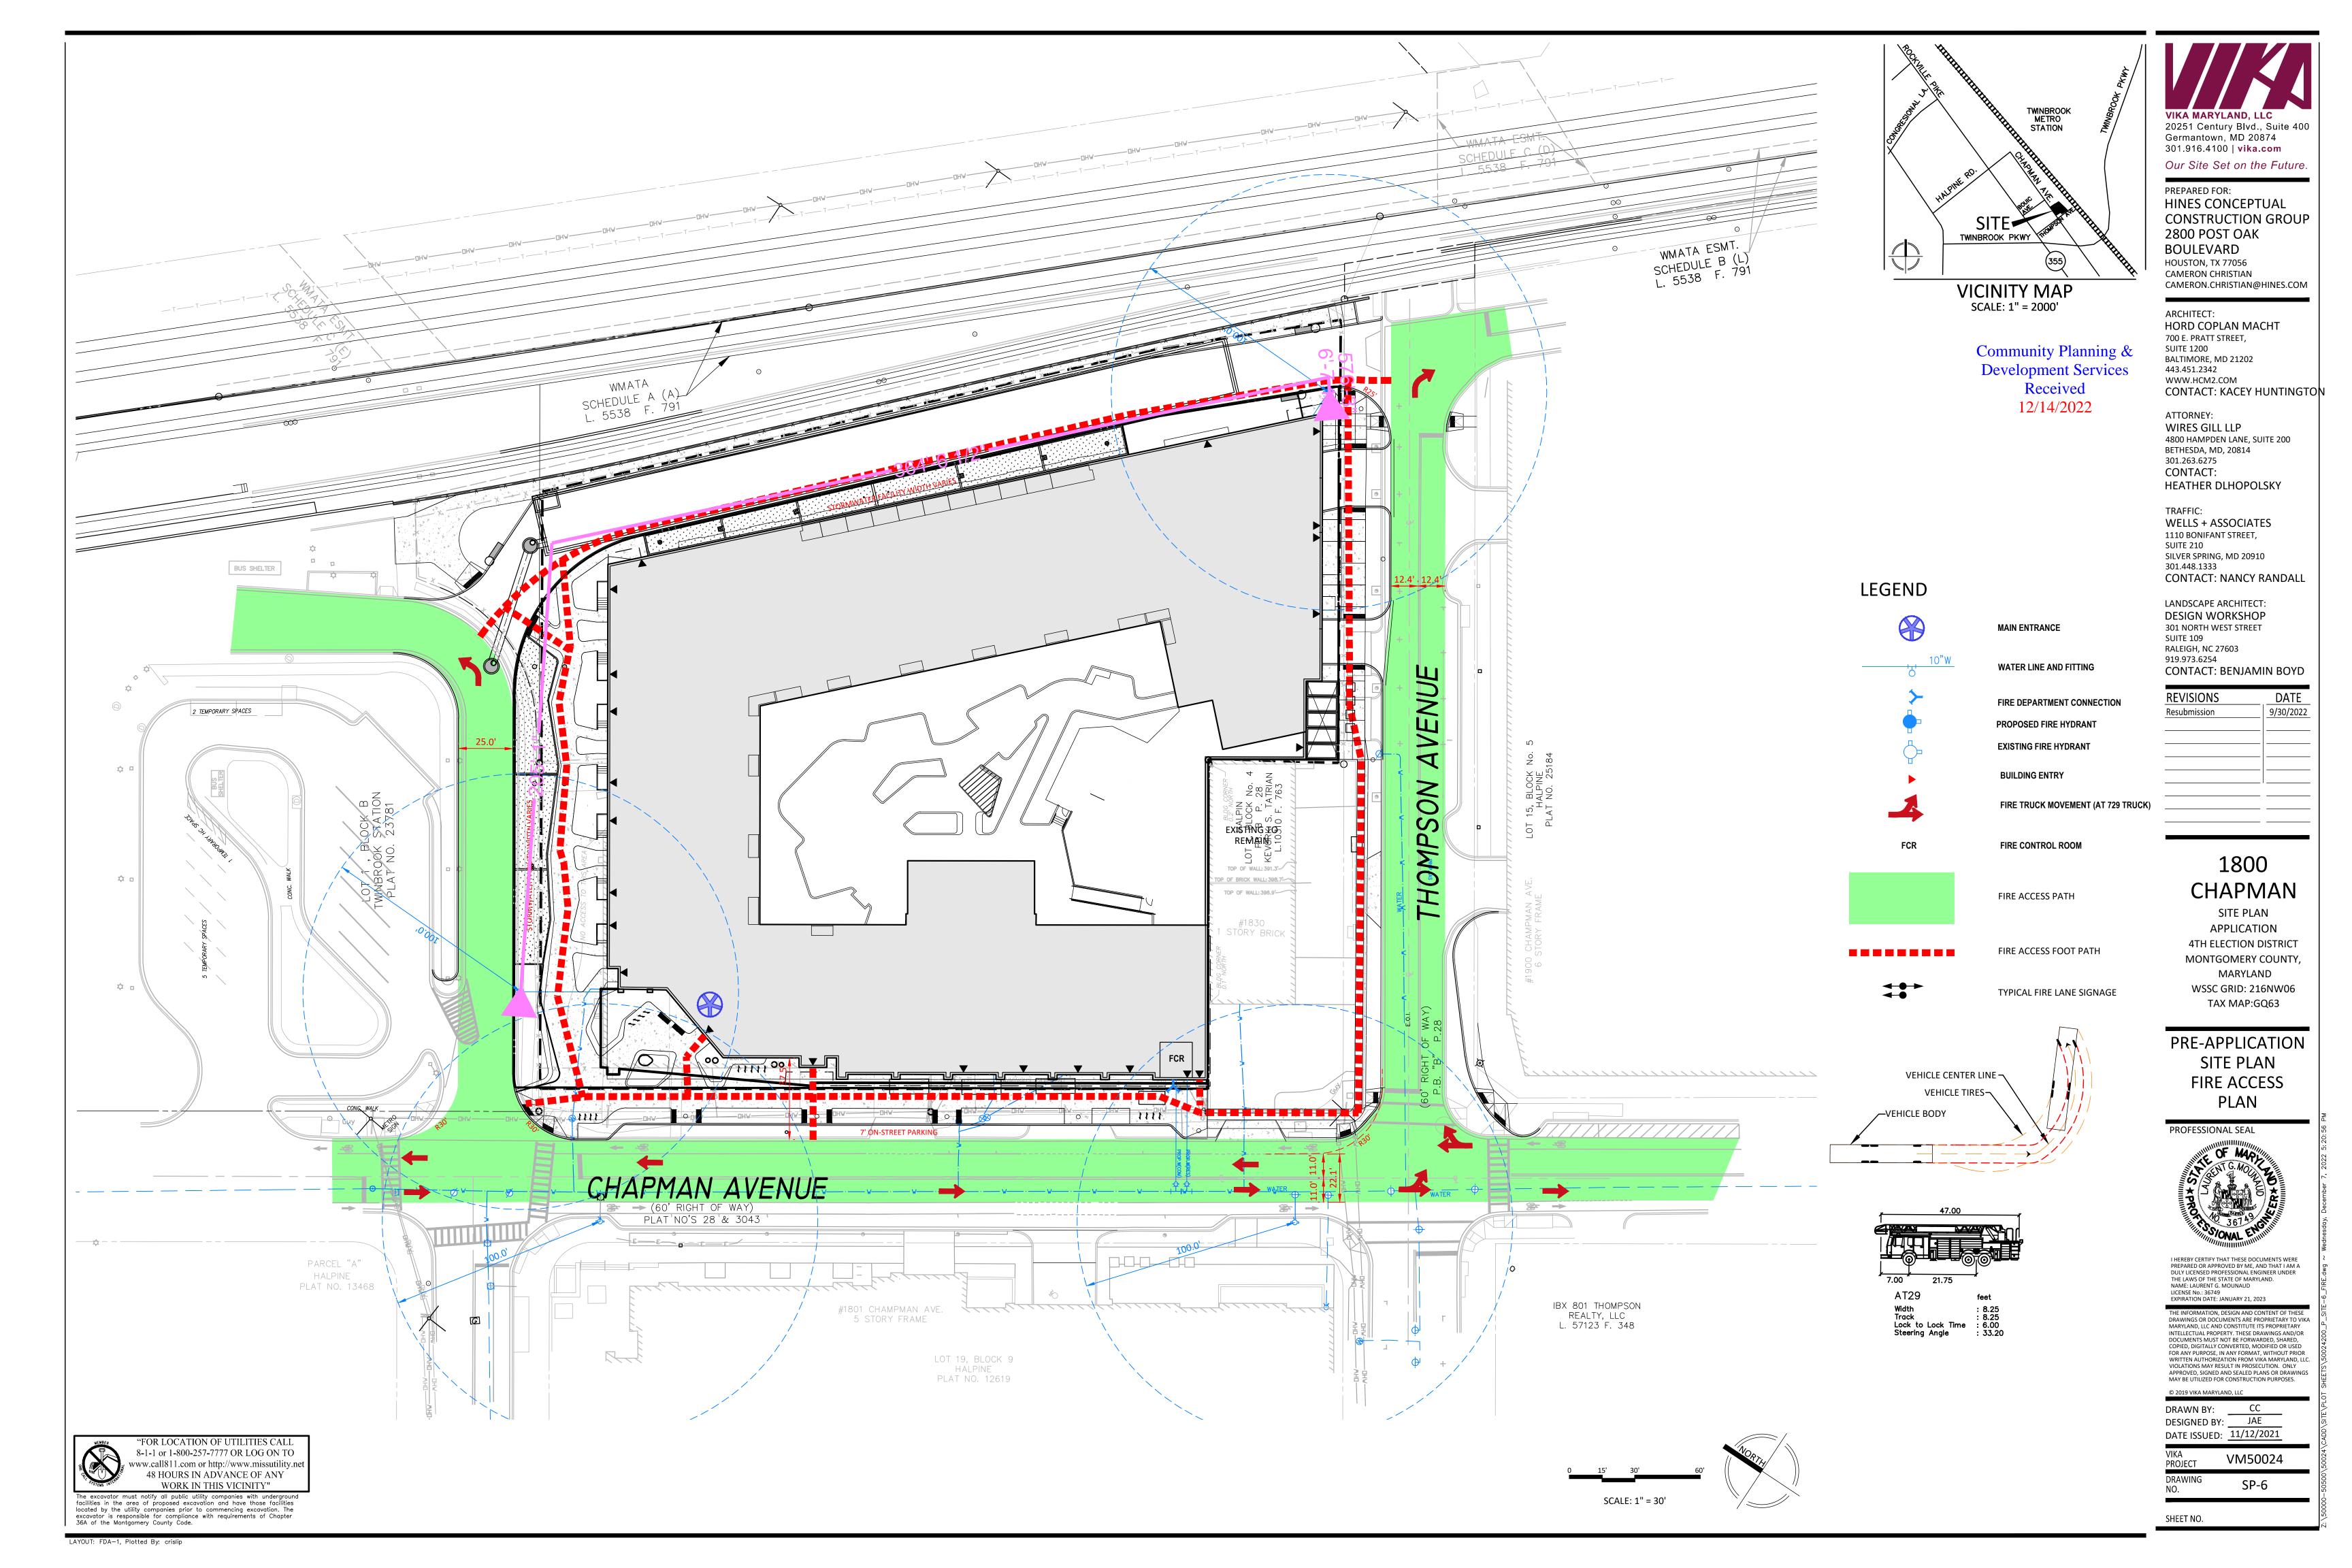LOT/PARCEL	BLOCK	TAX ACCT NO.	LIBER & FOLIO	PLAT NO.
LOT 2	4	04-00153095	L. 58429 F. 90	-
LOT 4	4	04-00143325	L. 51915 F. 375	-
LOT 5	4	04-00143336	L. 51915 F. 375	-
LOT 6	4	04-00143347	L. 51915 F. 375	-
LOT 1/N313	B	04-03629774	L F	23781

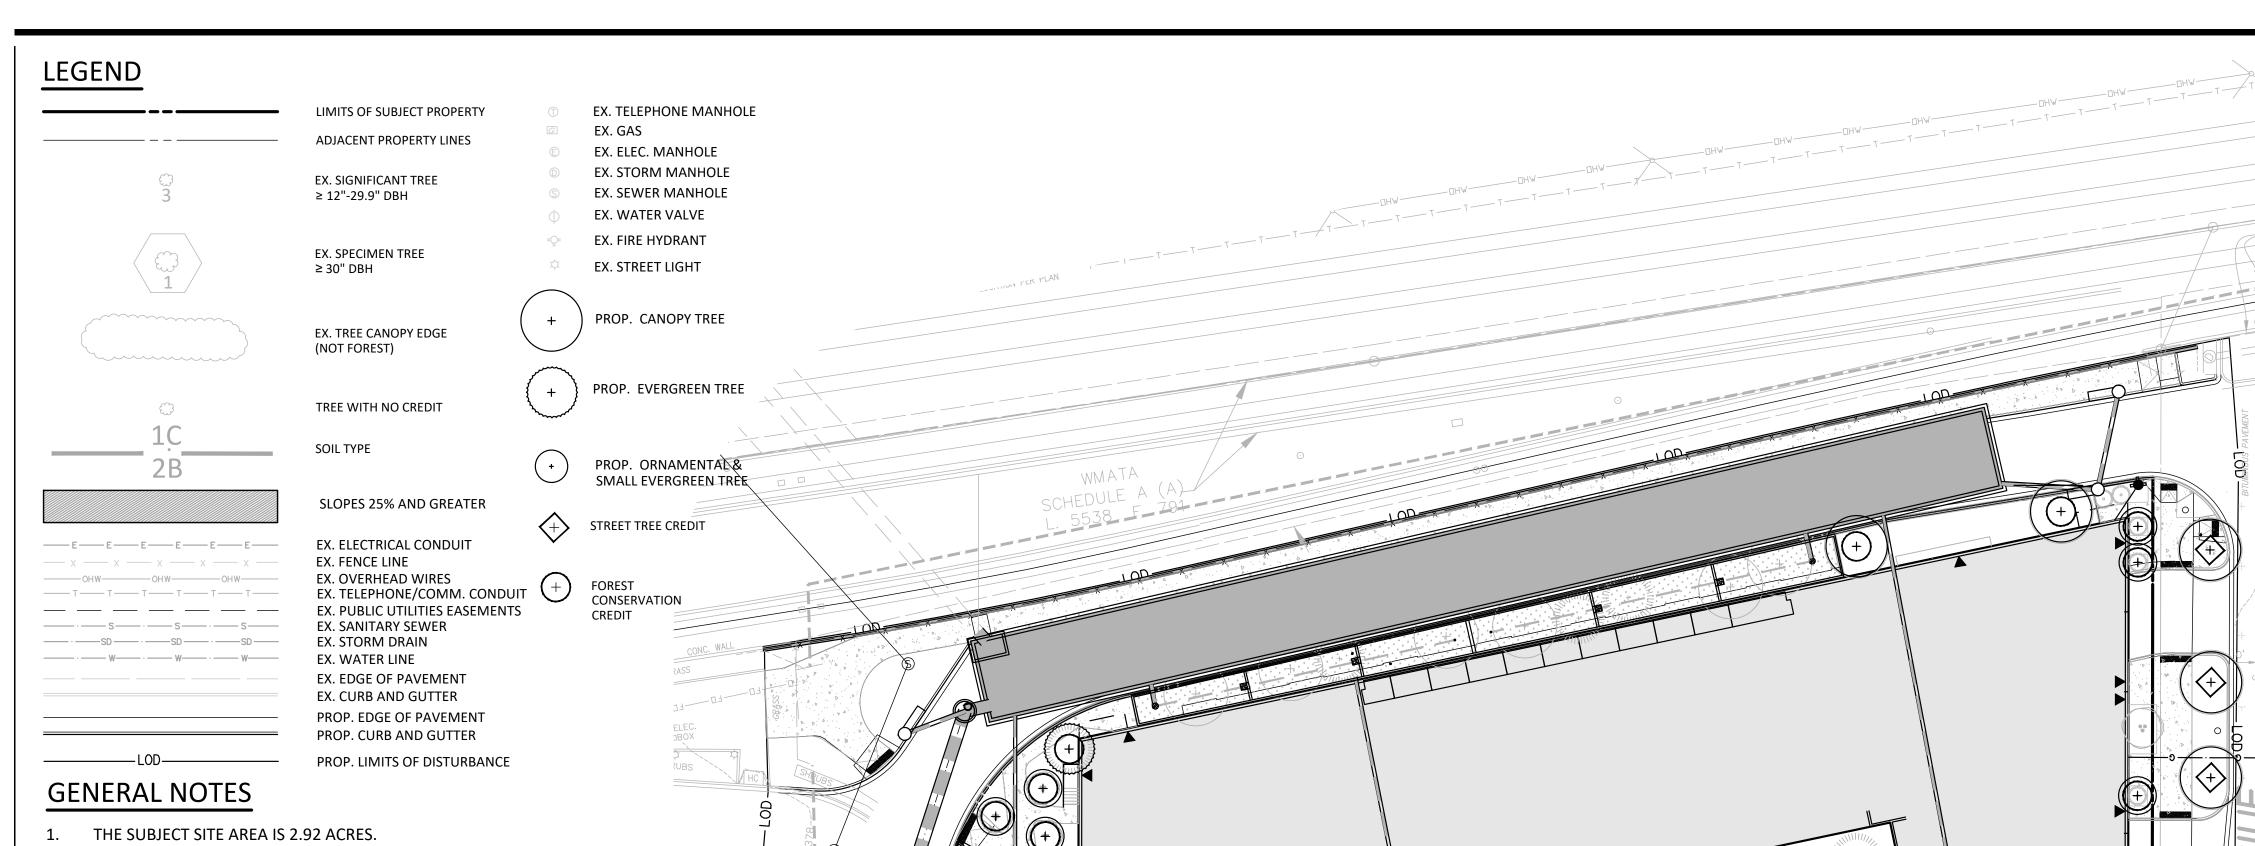
- 4. THE PROPERTY IS LOCATED ON WSSC MAP 216NW06.
- 5. THE SUBJECT PROPERTY IS LOCATED IN THE LOWER ROCK CREEK WATERSHED, A USE CLASS I/I-P STREAM. THERE IS NO MAPPED MNCPPC OR FEMA 100 YEAR FLOODPLAIN
- THERE ARE NO PERENNIAL OR INTERMITTENT STREAMS, SEEPS, OR SPRINGS OR THEIR ASSOCIATED BUFFERS LOCATED ON, OR WITHIN 200' OF THE SUBJECT PROPERTY BASED ON PERSONAL OBSERVATIONS ON-SITE ON NOVEMBER 5, 2020.
- PER U.S.FISH & WILDLIFE SERVICES' NATIONAL WETLANDS INVENTORY ON-LINE MAPPER (HTTP://WWW.FWS.GOV/WETLANDS/DATA/ MAPPER.HTML), MARYLAND'S ENVIRONMENTAL RESOURCES AND LAND INFORMATION NETWORK (MERLIN) (HTTP://WWW. MDMERLIN.NET/), AND FIELD VERIFICATION, THERE ARE NO WETLANDS OR THEIR ASSOCIATED BUFFERS LOCATED ON THE SUBJECT PROPERTY OR WITHIN THE REMAINDER OF THE NRI STUDY AREA. ACCESSED ON NOVEMBER 6, 2020.


RESOURCE DATA TABLE

ACREAGE OF TRACT (GROSS AREA)	2.24
ACREAGE OF TRACT REMAINING IN AGRICULTURAL USE	0.00
ACREAGE OF TOTAL EXISTING FOREST	0.00
ACREAGE OF 100-YR FLOODPLAINS	0.00
ACREAGE OF FOREST W/IN 100-YR FLOODPLAINS	0.00
ACREAGE OF WETLANDS	0.00
ACREAGE OF FOREST WITHIN WETLANDS	0.00
ACREAGE OF ENVIRONMENTAL BUFFERS	0.00
ACREAGE OF FOREST WITHIN ENVIRONMENTAL BUFFERS	0.00
LINEAR FEET AND AVERAGE WIDTH OF	Linear Feet: 0'
ENVIRONMENTAL BUFFER PROVIDED	Average Width: 0'


MINIMUM TREE COVER

•										
	MINIMUM TREE COVER									
	TRACT AREA SF	ZONING	MTC REQUIRED %	MTC SF REQUIRED						
	97,480	MXTD AND PD-TC	10	9,748						

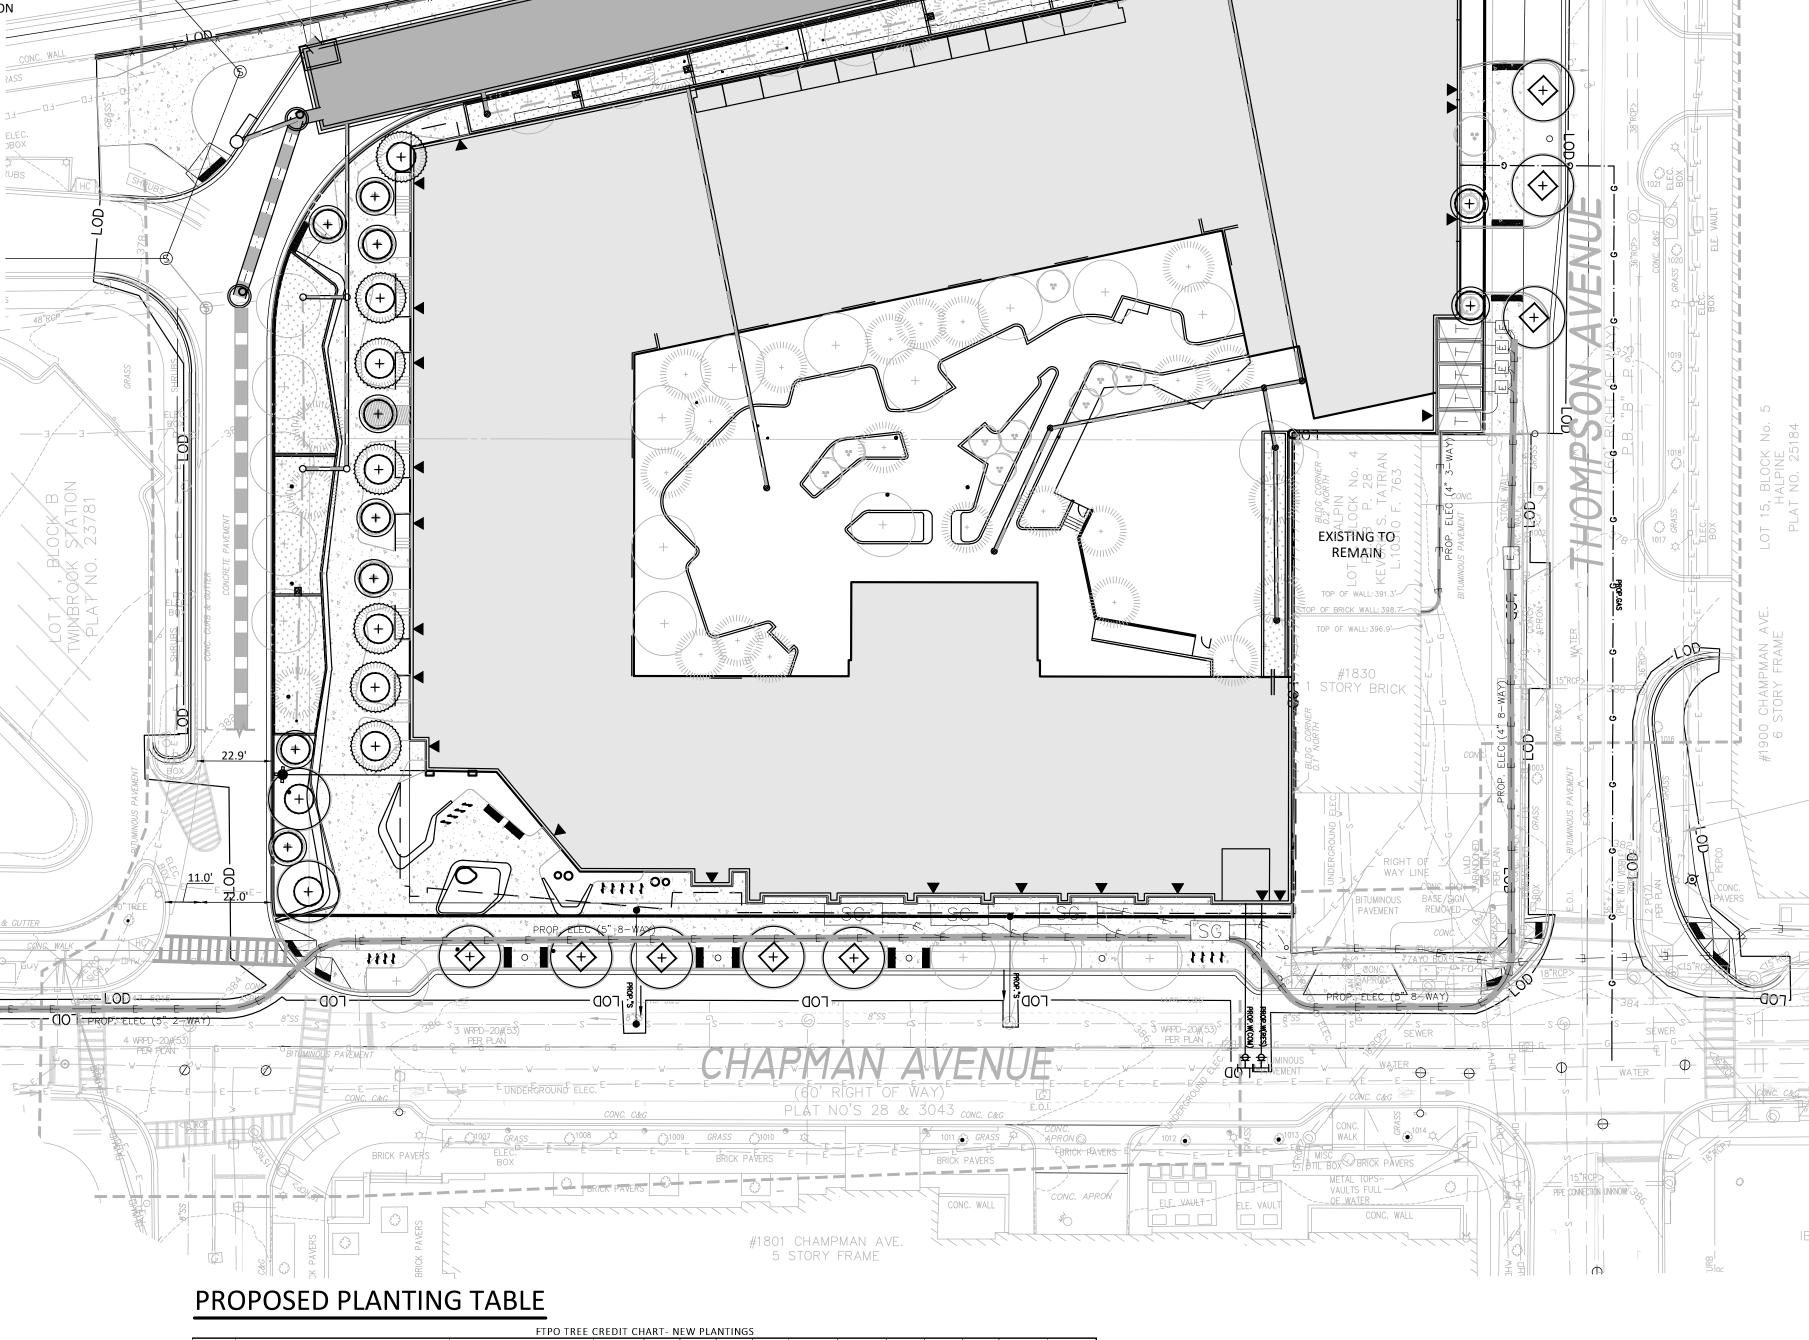

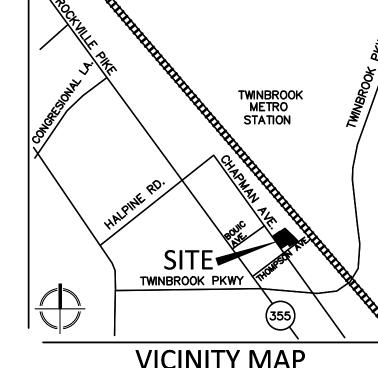

SCALE: 1" = 2000'

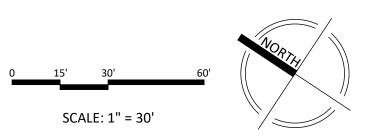

SOILS TABLE

SYMBOL	SOIL*	CHARACTERISTICS					
		PRIME	HIGHLY				
		AGRICULTURE**	ERODIBLE***	SERPENTINIC****	HYDRIC GROUP*	K FACTOR****	
400	Urban Land	NO	NO	NO	D	0.49	

- SOURCES: *USDA NRCS WEB SOIL SURVEY (http://websoilsurvey.sc.egov.usda.gov)
- **PAGE 140 TABLE 5 MONTGOMERY COUNTY, MARYLAND SOIL SURVEY *URBAN OR BUILT-UP AREAS OF THE PRIME AGRICULTURAL SOILS ARE NOT CONSIDERED PRIME FARMLAND PER THE
- THE MONTGOMERY COUNTY, MARYLAND SOIL SURVEY PAGE 140 TABLE 5 ** PAGE 67 APPENDIX C ERODIBLE SOILS LIST M-NCPPC MONTGOMERY COUNTY ENVIRONMENTAL GUIDELINES ****PAGE 120 MONTGOMERY COUNTY, MARYLAND SOIL SURVEY *****TABLE 16 PAGE 212 MONTGOMERY COUNTY, MARYLAND SOIL SURVE

FCP WORKSHEET

CITY OF ROCKVILLE FOREST CONSERVATION WORKSHEET

Twinbrook Hines (50024J)

NET TRACT AREA:

A. Total tract area . B. Deductions (land dedication not in construction on this plan, other deductions - specify)

LAND USE CAT	EGORY:				
ZONING:	R-400, R-200	R-90, R-75,	RMD10,	I-L, I-H, RPR, RPC,	Park
Place a "1"		R-60, R-150	RMD15,	MXT, MXC, MXNC,	
under the			RMD25	MXB, MXE, MXCD,	
column				MXTD, PD	
corresponding					
to the correct					
zone of the site					
Zone:	0	0	0	1	0

(choose only one) Afforestation Threshold x C =x C = 15% E. Conservation Threshold EXISTING FOREST COVER: F. Existing forest cover (within net tract) (Existing easement).....=

BREAK EVEN POINT: H. Breakeven Point (amount of forest retained so that no mitigation is required)....= I. Clearing permitted without mitigation

PROPOSED FOREST CLEARING: J. Total area of forest to be cleared .

R. Total planting requirement .

K. Total area of forest to be retained ... PLANTING REQUIREMENTS: L. Reforestation for clearing above conservation threshold=

G. Area of forest above conservation threshold=

M. Reforestation for clearing below conservation threshold= N. Credit for retention above conservation threshold= P. Total reforestation required .. Q. Total afforestation required ..

> Community Planning & **Development Services** Received 12/14/2022



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PREPARED FOR: HINES CONCEPTUAL **CONSTRUCTION GROUP** 2800 POST OAK BOULEVARD HOUSTON, TX 77056

CAMERON.CHRISTIAN@HINES.COM

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0.00 2.24

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0.00

0.34

0.34

REVISIONS 9/30/2022 12/08/2022

1800 **CHAPMAN**

SITE PLAN APPLICATION 4TH ELECTION DISTRICT MONTGOMERY COUNTY, MARYLAND WSSC GRID: 216NW06 TAX MAP:GQ63

PRELIMINARY **FOREST CONSERVATION** PLAN

PROFESSIONAL SEAL

I HEREBY CERTIFY THAT THESE DOCUMENTS WERE PREPARED OR APPROVED BY ME. AND THAT I AM A DULY LICENSED, REGISTERED LANDSCAPE ARCHITECT UNDER THE LAWS OF THE STATE OF MARYLAND. LA NAME: CHANDA BEAUFORT, RLA LICENSE NUMBER: 33112 EXPIRATION DATE: SEPTEMBER 7, 2024

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DRAWN BY: DESIGNED BY: ____CB DATE ISSUED: <u>10/14/2021</u>

PROJECT DRAWING

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SHEET NO. PFCP-1


QUANTITY	TREE TYPE	COMMON NAME	SIZE (LG SHADE, LG EG,ORN, SM EG)	ROOT BALL TYPE	SIZE- CAL/HT	LANDSCAPING NO CREDIT	LANDSCAPING MTC CREDIT ONLY	SIG. TREE REPLACEMENT CREDIT (OFF-SITE)	SIG. TREE REPLACEMENT CREDIT (ON-SITE.)	STREET TREE NO CREDIT	STREET TREE FC CREDIT ONLY	FC CREDIT	FC CREDIT (200 OR 400 SF x FC QUANTITY)	MTC CREDIT (200 OR 400 SF x MTC QUANTITY)
	Street Trees (not to exceed 25% of total requirement)													
9	Chapman Avenue - Shade Tree	TBD	LG SHADE	B&B	3.5"	0	0	0	0	4	5	0	2000	2400
5	Thompson Ave - Shade Tree	TBD	LG SHADE	B&B	3.5"	0	0	0	0	1	4	0	1600	1600
	On-Site Trees													
4	Shade Trees	TBD	LG SHADE	B&B	3.5"	0		0	0	0	0	4	1600	1600
8	Ornamental Trees	TBD	ORN	B&B	3.5"	0		0	0	0	0	8	1600	1600
7	Large Evergreen Trees	TBD	LG EVG	B&B	8' H	0		0	0	0	0	7	2800	2800
6	Small Evergreen Trees	TBD	SM EVG	B&B	8' H	0		0	0	0	0	4	800	800
				TO	ALS	0	0	0	0	5	9	23	10,400	10,800
				REQUIR	EMENTS	N/A		13	36				14,811	9,748
* PER PROJ	ECT PLAN APPROVAL THE PROJECT IS ALLOWED UP TO 60% C		LIEU OPTION*							4,411 SF				

SIGNIFICANT TREE REPLACEMENT REQUIRED = 136 TO BE MET WITH FEE-IN-LIEU

WORK IN THIS VICINITY" The excavator must notify all public utility companies with underground facilities in the area of proposed excavation and have those facilities located by the utility companies prior to commencing excavation. The excavator is responsible for compliance with requirements of Chapter 36A of the Montgomery County Code.

"FOR LOCATION OF UTILITIES CALL 8-1-1 or 1-800-257-7777 OR LOG ON TO

www.call811.com or http://www.missutility.ne 48 HOURS IN ADVANCE OF ANY

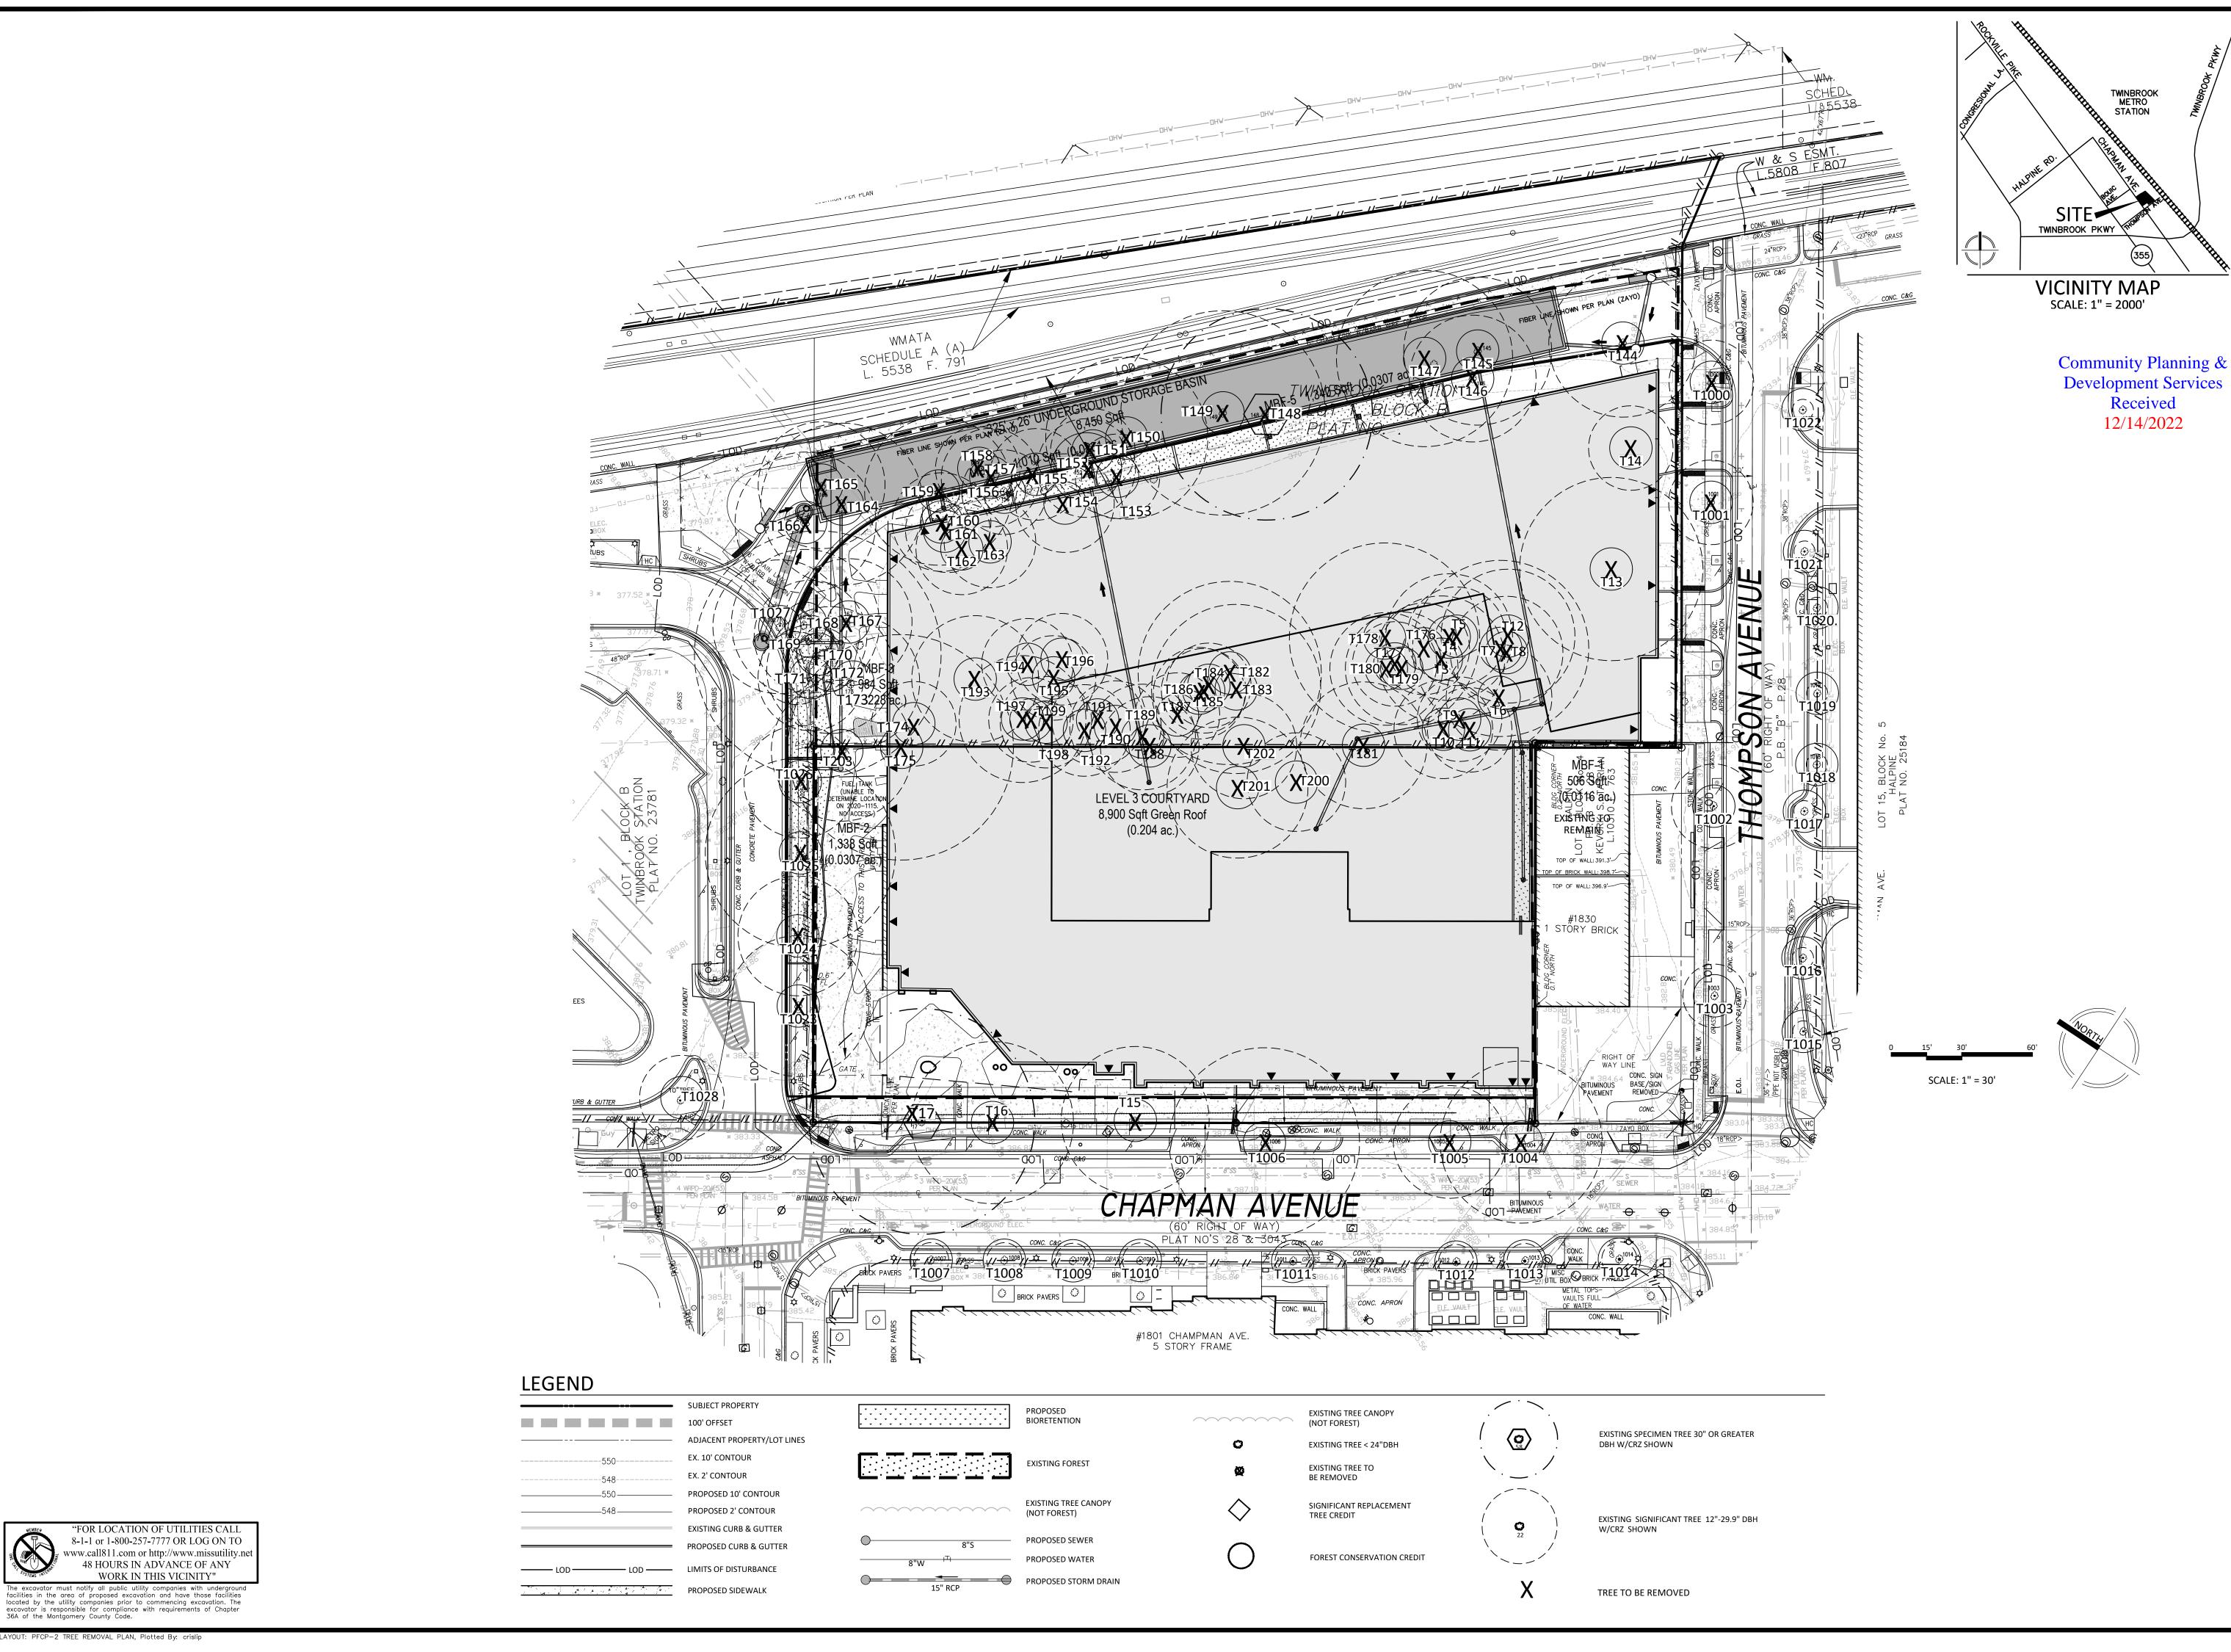

20251 Century Blvd., Suite 400

Germantown, MD 20874 301.916.4100 | vika.com Our Site Set on the Future.

PREPARED FOR:

HINES CONCEPTUAL **CONSTRUCTION GROUP** 2800 POST OAK **BOULEVARD**

HOUSTON, TX 77056 CAMERON CHRISTIAN CAMERON.CHRISTIAN@HINES.COM ARCHITECT: HORD COPLAN MACHT

700 E. PRATT STREET, **SUITE 1200** BALTIMORE, MD 21202 443.451.2342 WWW.HCM2.COM CONTACT: KACEY HUNTINGTON

ATTORNEY: WIRES GILL LLP 4800 HAMPDEN LANE, SUITE 200 BETHESDA, MD, 20814 301.263.6275 CONTACT: HEATHER DLHOPOLSKY

TRAFFIC: WELLS + ASSOCIATES 1110 BONIFANT STREET, SUITE 210 SILVER SPRING, MD 20910 301.448.1333 CONTACT: NANCY RANDALL

LANDSCAPE ARCHITECT: **DESIGN WORKSHOP** 301 NORTH WEST STREET SUITE 109 RALEIGH, NC 27603 919.973.6254 CONTACT: BENJAMIN BOYD

REVISIONS	DATE
Resubmission	9/30/2022
Resubmission	12/08/2022
	·

1800 CHAPMAN

SITE PLAN APPLICATION 4TH ELECTION DISTRICT MONTGOMERY COUNTY, MARYLAND WSSC GRID: 216NW06 TAX MAP:GQ63

PRELIMINARY **FOREST** CONSERVATION PLAN TREE REMOVAL

PROFESSIONAL SEAL

I HEREBY CERTIFY THAT THESE DOCUMENTS WERE PREPARED OR APPROVED BY ME, AND THAT I AM A DULY LICENSED, REGISTERED LANDSCAPE ARCHITECT UNDER THE LAWS OF THE STATE OF MARYLAND. LA NAME: CHANDA BEAUFORT, RLA
LICENSE NUMBER: 33112
EXPIRATION DATE: SEPTEMBER 7, 2024


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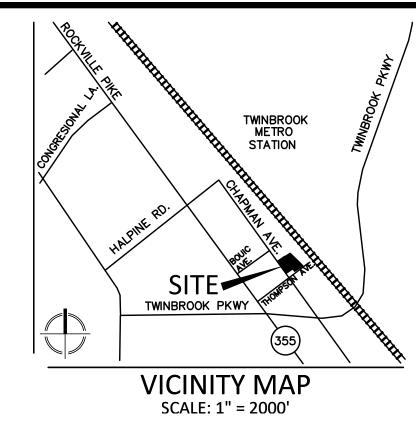
DRAWN BY:	
DESIGNED BY: DATE ISSUED:	
VIKA PROJECT	

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SHEET NO. PFCP-2

#	SCIENTIFIC NAME	COMMON NAME	рвн	Area CRZ	CTLA %	COR CTLA %	PFCP Remarks	/FFCP PREVIOUS FTP PLAN #	PREV.CREDIT	DISPOSITION	OWED	REPLACEMENT TREES REQD.	CREDIT TYPE	MAXIMUM CREDIT
	CAPE SETTING >/= 12" Robinia pseudoacacia	DBH (NO EXISTING Black Locust	CREDI [*]	Γ) 2043	75					Remove		1	LG SHADE	0
4	Robinia pseudoacacia	Black Locust	18	2290	75					Remove		1	LG SHADE	0
5 6	Robinia pseudoacacia Robinia pseudoacacia	Black Locust Black Locust	14 15	1385 1590	75 75					Remove Remove		1	LG SHADE	0
7	Robinia pseudoacacia	Black Locust	25 16	4418	68 78					Remove		3	LG SHADE	C
8 9	Robinia pseudoacacia Robinia pseudoacacia	Black Locust Black Locust	16 12	1810 1018	78 72					Remove Remove		1	LG SHADE	C
.0	Robinia pseudoacacia	Black Locust	14	1385	68 72					Remove		1	LG SHADE	0
.1	Robinia pseudoacacia Robinia pseudoacacia	Black Locust Black Locust	12 19	1018 2552	72 78					Remove Remove		2	LG SHADE LG SHADE	(
.3	Robinia pseudoacacia	Black Locust	26	4778	75 75					Remove		3	LG SHADE	(
.4 .5	Juniperus virginiana Acer rubrum	Redcedar Red Maple	12 21	1018 3117	75 56					Remove Remove		2	LG EVG LG SHADE	(
.6	Acer rubrum	Red Maple	23	3739	41					Remove		2 6	LG SHADE	(
.7 44	Acer rubrum Pinus strobus	Red Maple White Pine	32 21	7238 3117	50 72					Remove Remove		2	LG SHADE LG EVG	(
	Robinia pseudoacacia	Black Locust	21 18	3117	66 75					Remove		2	LG SHADE LG EVG	(
46 47	Pinus strobus Pinus strobus	White Pine White Pine	25	2290 4418	75 75					Remove Remove		3	LG EVG	(
	Pinus strobus	White Pine	30 29	6362	78 78					Remove		6	LG EVG LG EVG	(
	Pinus strobus Robinia pseudoacacia	White Pine Black Locust	29 23	5945 3739	78 81					Remove Remove		2	LG SHADE	(
	Robinia pseudoacacia Robinia pseudoacacia	Black Locust Black Locust	12 14	1018 1385	81 81					Remove Remove		1	LG SHADE	(
	Robinia pseudoacacia	Black Locust Black Locust	12	1018	81					Remove		1	LG SHADE	
54 55	Robinia pseudoacacia Robinia pseudoacacia	Black Locust Black Locust	14 13	1385 1195	88 84					Remove Remove		1	LG SHADE	(
56	Robinia pseudoacacia	Black Locust Black Locust	12	1018	88					Remove		1	LG SHADE	
57 58	Pinus strobus	White Pine White Pine	14 12	1385 1018	81 72					Remove Remove		1	LG EVG LG EVG	
59	Pinus strobus Pinus strobus	White Pine White Pine	21	3117	75					Remove Remove		2	LG EVG	
50 51	Robinia pseudoacacia Robinia pseudoacacia	Black Locust Black Locust	14 12	1385 1018	72 69					Remove Remove		1	LG SHADE	
62	Robinia pseudoacacia	Black Locust Black Locust	13	1018	69					Remove Remove		1	LG SHADE	
63 64	Robinia pseudoacacia Pinus strobus	Black Locust White Pine	13 23	1195 3739	84 59					Remove Remove		2	LG SHADE LG EVG	-
65	Pinus strobus	White Pine	18	2290	69					Remove		1	LG EVG	
66 67	Pinus strobus Pinus strobus	White Pine White Pine	20 18	2827 2290	75 75					Remove Remove		2	LG EVG	
58	Populus deltoides	Cottonwood	21	3117	75 75					Remove		2	LG SHADE	
69 70	Populus deltoides Populus deltoides	Cottonwood Cottonwood	25 35	4418 8659	72 72					Remove Remove		3 6	LG SHADE	(
71	Mours alba	White Mulberry	15	1590	69					Remove		1	LG SHADE	
72 73	Pinus strobus Pinus strobus	White Pine White Pine	18 19	2290 2552	75 75					Remove Remove		2	LG EVG	1
74	Ulmus rubra	Slippery Elm	12	1018	75					Remove		1	LG SHADE	(
75 76	Acer saccharinum Robinia pseudoacacia	Silver Maple Black Locust	32 13	7238 1195	78 81					Remove Remove		6	LG SHADE	(
77	Robinia pseudoacacia	Black Locust	12	1018	72					Remove		1	LG SHADE	(
78 79	Robinia pseudoacacia Robinia pseudoacacia	Black Locust Black Locust	27 16	5153 1810	78 75					Remove Remove		3	LG SHADE	(
80	Robinia pseudoacacia	Black Locust	16	1810	75					Remove		1	LG SHADE	(
81 82	Robinia pseudoacacia Populus deltoides	Black Locust Cottonwood	18 26	2290 4778	69 69					Remove Remove		3	LG SHADE	(
83	Populus deltoides	Cottonwood	24	4072	75 75					Remove		2	LG SHADE	(
84 85	Robinia pseudoacacia Robinia pseudoacacia	Black Locust Black Locust	12 12	1018	75 72					Remove Remove		1	LG SHADE LG SHADE	(
86	Robinia pseudoacacia	Black Locust	13	1195	75 70					Remove		1	LG SHADE	(
87 88	Robinia pseudoacacia Robinia pseudoacacia	Black Locust Black Locust	12 14	1018 1385	78 81					Remove Remove		1	LG SHADE LG SHADE	(
	Robinia pseudoacacia	Black Locust	15	1590	81					Remove		1	LG SHADE	
	Robinia pseudoacacia Robinia pseudoacacia	Black Locust Black Locust	13 13	1195 1195	75 78					Remove Remove		1	LG SHADE	
	Robinia pseudoacacia	Black Locust	13	1195	78 75					Remove		1	LG SHADE	
93 94	Robinia pseudoacacia Robinia pseudoacacia	Black Locust Black Locust	18 13	2290 1195	75 75					Remove Remove		1	LG SHADE	
	Robinia pseudoacacia	Black Locust	12	1018	78					Remove		1	LG SHADE	
96 97	Robinia pseudoacacia Robinia pseudoacacia	Black Locust Black Locust	13 18	1195 2290	78 72					Remove Remove		1	LG SHADE	
	Robinia pseudoacacia	Black Locust	12 13	1018	75 72					Remove		1	LG SHADE	
	Robinia pseudoacacia Morus alba	Black Locust White Mulberry	13 14	1195 1385	72 56					Remove Remove		1	LG SHADE	
01 02	Pyrus calleryana Prunus serotina	Callery Pear Black Cherry	20 15	2827 1590	59 50					Remove Remove		2	LG SHADE	
03	Morus alba	White Mulberry	20	2827	63					Remove		2	LG SHADE	
23 24	Platanus occidentalis Platanus occidentalis	American Sycamore American Sycamore	20 17	2827	81 81					Remove Remove		2	LG SHADE	(
25	Platanus occidentalis	American Sycamore	27	5153	81					Remove		3	LG SHADE	(
!6	Platanus occidentalis	American Sycamore	16	1810	84					Remove		130	LG SHADE	(
					-	number mu	ust include F if previ	ous FC credit was assigned)		Pomorit	0			
0	Platanus x. acerifolia Platanus x. acerifolia	American Sycamore American Sycamore	12 11	1018 855	84 81					Remove Remove	0 0	1		
3	Platanus x. acerifolia Platanus x. acerifolia	American Sycamore American Sycamore	12 9	1018 573	81 81					Save Save	N/A N/A	0	-	
13	Prunus spp.	Ornamental Cherry	23	3739	81 44					Remove	0	1		
5 6	Prunus spp. Prunus spp.	Ornamental Cherry Ornamental Cherry	16 27	1810 5153	44 47					Remove Remove	0 0	1		
)7	Quercus imbricaria	Shingle Oak	5	177	91					Save	N/A	0	-	(
)8)9	Quercus imbricaria Quercus imbricaria	Shingle Oak Shingle Oak	5 5	177 177	88 88					Save Save	N/A N/A	0	-	
.0	Quercus imbricaria	Shingle Oak	5	177	88					Save	N/A	0		
.1	Quercus imbricaria Quercus imbricaria	Shingle Oak Shingle Oak	5 5	177 177	88 88					Save Save	N/A N/A	0	-	
.3	Quercus imbricaria	Shingle Oak	5	177	88					Save	N/A	0		,
L4 L5	Quercus imbricaria Platanus occidentalis	Shingle Oak American Sycamore	5 3	177 64	91 88					Save Save	N/A N/A	0	-	1
L5 L6	Platanus occidentalis Platanus occidentalis	American Sycamore American Sycamore	3	64	88 88					Save Save	N/A N/A	0		
L7 18	Platanus occidentalis	American Sycamore	3 3	64 64	84 85					Save	N/A N/A	0	-	(
L8 L9	Platanus occidentalis Platanus occidentalis	American Sycamore American Sycamore	3	64	85 84					Save Save	N/A N/A	0		
	Platanus occidentalis Platanus occidentalis	American Sycamore	3 3	64	84 88					Save	N/A	0	-	(
	Platanus occidentalis Platanus occidentalis	American Sycamore American Sycamore	3	64	88 81					Save Save	N/A N/A	0		(
27	Platanus occidentalis	American Sycamore	19	2552	84					Remove	0	1		(
	Platanus occidentalis	American Sycamore	12	1018	81					Save	N/A	0		(



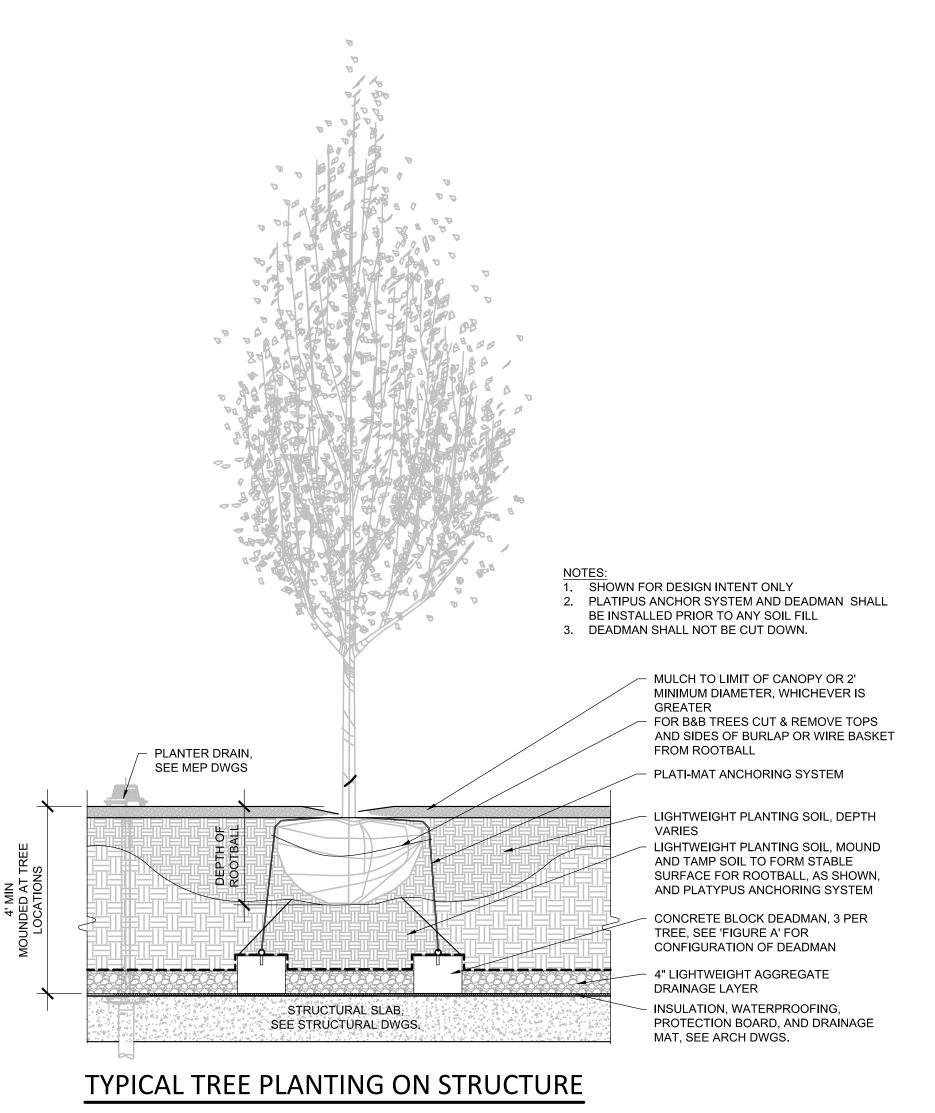

Community Planning & **Development Services** Received 12/14/2022

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PREPARED FOR: HINES CONCEPTUAL **CONSTRUCTION GROUP** 2800 POST OAK **BOULEVARD** HOUSTON, TX 77056 CAMERON CHRISTIAN CAMERON.CHRISTIAN@HINES.COM

ARCHITECT: HORD COPLAN MACHT 700 E. PRATT STREET, **SUITE 1200** BALTIMORE, MD 21202 443.451.2342 WWW.HCM2.COM CONTACT: KACEY HUNTINGTON

ATTORNEY: WIRES GILL LLP 4800 HAMPDEN LANE, SUITE 200 BETHESDA, MD, 20814 301.263.6275 CONTACT: HEATHER DLHOPOLSKY

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LANDSCAPE ARCHITECT: DESIGN WORKSHOP 301 NORTH WEST STREET SUITE 109 RALEIGH, NC 27603 919.973.6254 CONTACT: BENJAMIN BOYD

REVISIONS	DATE
Resubmission	9/30/2022
Resubmission	12/08/2022

1800 CHAPMAN

SITE PLAN APPLICATION 4TH ELECTION DISTRICT MONTGOMERY COUNTY, MARYLAND WSSC GRID: 216NW06 TAX MAP:GQ63

PRELIMINARY **FOREST** CONSERVATION **TABLES**

PROFESSIONAL SEAL

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LA NAME: CHANDA BEAUFORT, RLA

LICENSE NUMBER: 33112

EXPIRATION DATE: SEPTEMBER 7, 2024

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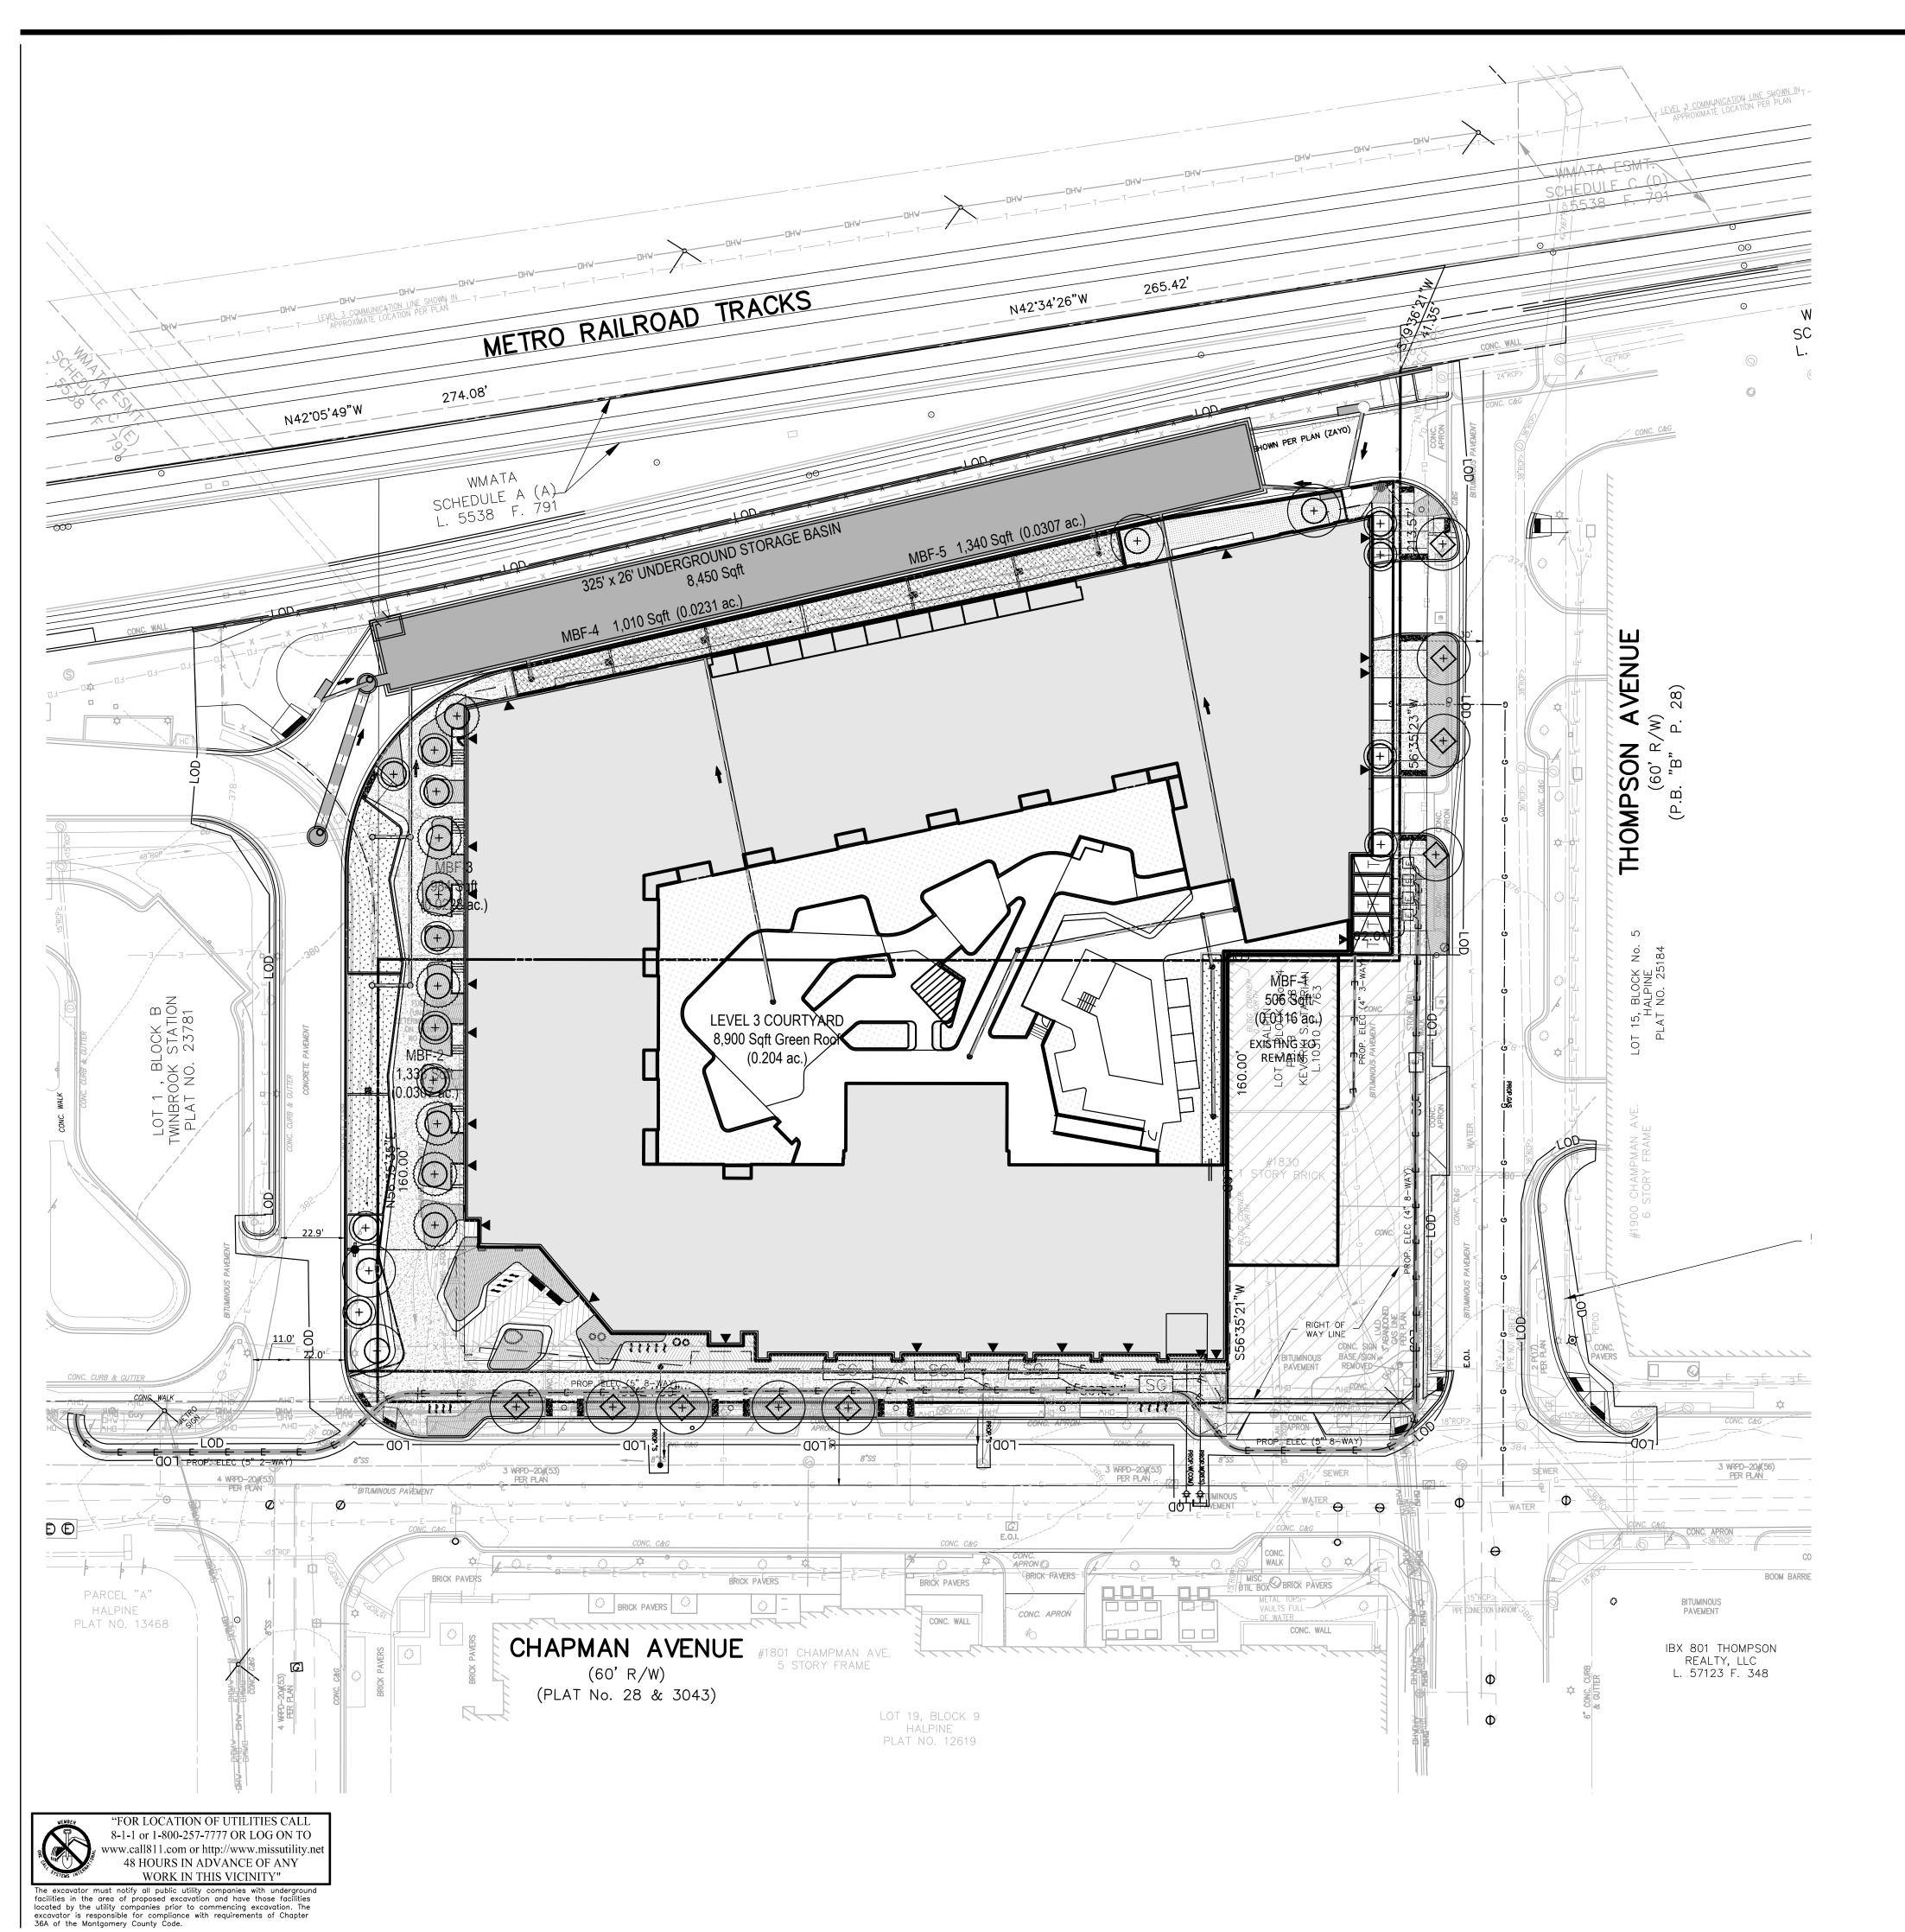
DRAWN BY: DLK DESIGNED BY: DLK DATE ISSUED: <u>10/14/2021</u>

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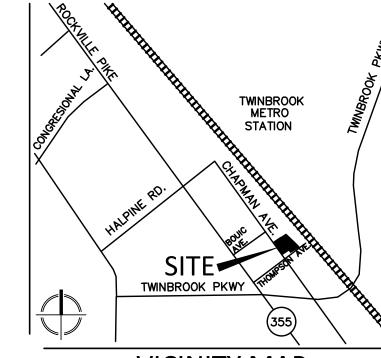
VIKA PROJECT DRAWING

SHEET NO. PFCP-3

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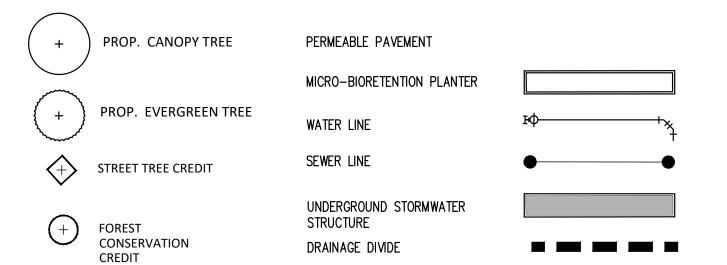


Community Planning & **Development Services** Received 12/14/2022



VICINITY MAP SCALE: 1" = 2000'


LEGEND:



CITY OF ROCKVILLE FOREST CONSERVATION WORKSHEET Twinbrook Hines (50024J)

NET TRACT AREA:

C. Net Tract Are	ea			is plan, other deductions			0.00 2.24
LAND USE CAT ZONING: Place a "1" under the column corresponding to the correct zone of the site	EGORY: R-400, R-200	R-90, R-75, R-60, R-150	RMD10, RMD15, RMD25	I-L, I-H, RPR, RPC, MXT, MXC, MXNC, MXB, MXE, MXCD, MXTD, PD	Park		
Zone: (choose only one	0	0	0	1	0		
D. Afforestation E. Conservation	Threshold				15% 15%	x C = x C =	0.34 0.34
F. Existing fores G. Area of fores	st cover (within			ment)= =			0.00 0.00
BREAK EVEN F H. Breakeven Pe I. Clearing perm	oint (amount o			o mitigation is required)	.=		0.00 0.00
PROPOSED FO	REST CLEAR	ING:					
J. Total area of t	forest to be ref						0.00 0.00
M. ReforestationN. Credit for reteP. Total reforest	for clearing about the forclearing bention above contion required ation required	elow conservation th	tion threshoreshold	old= = =			0.00 0.00 0.00 0.00 0.34

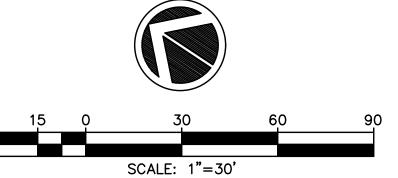



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REVISIONS Resubmission 9/30/2022

1800 **CHAPMAN**

SITE PLAN APPLICATION 4TH ELECTION DISTRICT MONTGOMERY COUNTY, MARYLAND WSSC GRID: 216NW06 TAX MAP:GQ63

STORMWATER **MANAGEMENT** FCP OVERLAY



I HEREBY CERTIFY THAT THESE DOCUMENTS WERE PREPARED OR APPROVED BY ME, AND THAT I AM A
DULY LICENSED PROFESSIONAL ENGINEER UNDER THE LAWS OF THE STATE OF MARYLAND.
NAME: LAURENT G. MOUNAUD LICENSE No.: 36749 EXPIRATION DATE: JANUARY 21, 2023

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DESIGNED BY: ____JAE DATE ISSUED: 11/12/2021


DRAWING

SHEET NO. 1 OF 1

VM50024 PROJECT

TWINBROOK HINES PAVEMENT MARKING AND SIGNAGE PLAN

4TH ELECTION DISTRICT ROCKVILLE MONTGOMERY COUNTY, MARYLAND

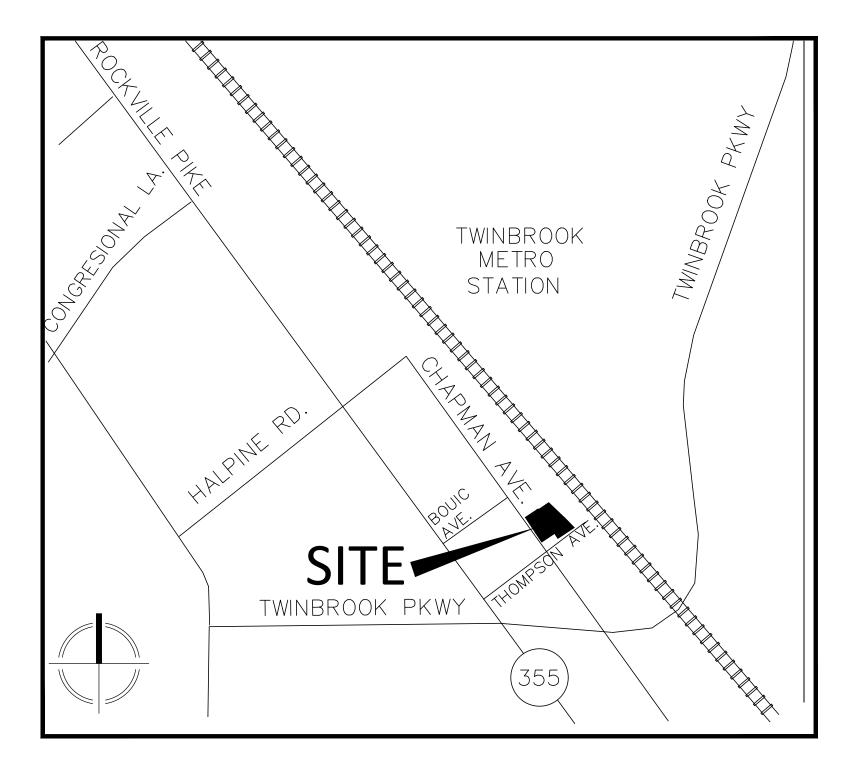

VICINITY MAP

SCALE: 1" = 1000'

SHEET INDEX

PMS-1 OF 3 PAVEMENT MARKING AND SIGNAGE PLAN COVER SHEET PMS-2 OF 3 PAVEMENT MARKING AND SIGNAGE PLAN PMS-3 OF 3 PAVEMENT MARKING AND SIGNAGE DETAILS

CITY OF ROCKVILLE SIGNING AND MARKING NOTES:

- ALL SIGNING MARKING SHALL BE DONE IN ACCORDANCE WITH THE LATEST MARYLAND MANUAL ON UNIFORM TRAFFIC CONTROL DEVICES (MD-MUTCD), MARYLAND STATE HIGHWAY ADMINISTRATION'S BOOK OF STANDARDS, SPECIFICATIONS AND GUIDELINES.
- ALL SIGNS SHALL BE DONE ON DIAMOND GRADE REFLECTIVE SHEETING.
- CROSSWALK MARKING SHALL BE DONE USING 12 INCHES WIDE WHITE HEAT APPLIED PREFORMED THER MOPLASTIC ADA RAMPS SHALL BE PROVIDED AT ALL CROSSWALKS. WHEN CROSSWALK IS HATCHED, IT SHOULD BE DONE USING A LADDER PATTERN HATCHING AND THE SPACING BETWEEN THE HATCHING SHOULD BE 2 FEET.
- STOP LINE SHOULD BE 24 INCH WIDE WHITE HEAT APPLIED PREFORMED THERMOPLASTIC. THE SPACING BETWEEN THE STOP LINE AND THE CROSSWALK MARKING SHALL BE 4 FEET AT A MINIMUM.
- TRAVEL LANE MARKING SHALL BE DONE USING 5 INCHES WIDE WHITE REFLECTIVE LEAD FREE THERMOPLASTIC.
- WHEN SIGNS ARE INSTALLED IN CONCRETE, A PVC SLEEVE SHALL BE PROVIDED USING 40 SCHEDULE PVC (4" DIAMETER).
- NO PARKING SIGNS SHALL BE INSTALLED AT A 45 DEGREE ANGLE.
- PEDESTRIAN CROSSING SIGNS SHOULD BE INSTALLED AT MARKED CROSSWALKS AND THE BACKGROUND COLOR OF THE SIGNS SHOULD BE FLUORESCENT YELLOW GREEN (FYG).
- SIGN HEIGHT SHALL BE MINIMUM 7 FEET HIGH FROM THE BOTTOM OF THE SIGN FACE TO THE GROUND.
- "MAXIMUM FINE \$250" SIGN (12"X6") SHALL BE PLACED UNDERNEATH ALL HANDICAPPED PARKING SIGNS.
- THE STREET-NAME SIGNS FOR PUBLIC STREETS SHOULD HAVE BLUE BACKGROUND WITH WHITE LETTERING.
- ALL STREET NAME SIGNS WILL BE ON A 9" EXTRUDED ALUMINUM BLANK WITH A MAXIMUM LENGTH OF 48". ALL LETTERING SHOULD BE COMPOSED OF INITIAL UPPER-CASE LETTERS 6" IN HEIGHT AND LOWER-CASE LETTERS 4.5" IN HEIGHT USING HIGHWAY FONTS. ON THE LEFT SIDE OF THE BLANK, THERE MUST BE ROOM FOR A 6"X6" CITY LOGO. IF THE LETTERING OF THE STREET NAME WILL NOT FIT ON A 48" LENGTH BLANK THAN THE CITY LOGO MAY BE OMITTED TO ALLOW THE LETTERING TO FI ON THE BLANK.
- PRIVATE STREET NAME SIGNS SHOULD HAVE WHITE BACKGROUND WITH BLACK LETTERING, BUT THE CITY LOGO WILL NOT BE ON THEM, LETTERING STANDARD SHALL BE THE SAME AS THOSE OF PROBLIC STREET NAME SIGNS EXCEPT THE CITY LOGO.
- WHEN SIGN POSTS ARE NEEDED, 2# GALVANIZED "U" CHANNEL POSTS OR GALVANIZED BREAKAWAY TUBULAR STEEL SIGN POSTS (MD SHA STANDARD # 802.04) CAN BE USED.

"FOR LOCATION OF UTILITIES CALL 8-1-1 or 1-800-257-7777 OR LOG ON TO www.call811.com or http://www.missutility.ne 48 HOURS IN ADVANCE OF ANY WORK IN THIS VICINITY"

The excavator must notify all public utility companies with undergrour facilities in the area of proposed excavation and have those facilities located by the utility companies prior to commencing excavation. The excavator is responsible for compliance with requirements of Chapter 36A of the Montgomery County Code. Community Planning & **Development Services** Received 12/14/2022



PREPARED FOR: HINES CONCEPTUAL **CONSTRUCTION GROUP** 2800 POST OAK BOULEVARD HOUSTON, TX 77056 **CAMERON CHRISTIAN** CAMERON.CHRISTIAN@HINES.COM

Our Site Set on the Future

ARCHITECT: HORD COPLAN MACHT 700 E. PRATT STREET, **SUITE 1200** BALTIMORE, MD 21202 443.451.2342 WWW.HCM2.COM CONTACT: KACEY HUNTINGTON

WIRES GILL LLP 4800 HAMPDEN LANE, SUITE 200 BETHESDA, MD, 20814 301.263.6275 CONTACT: **HEATHER DLHOPOLSKY**

ATTORNEY:


TRAFFIC: WELLS + ASSOCIATES 1110 BONIFANT STREET, SILVER SPRING, MD 20910 301.448.1333 **CONTACT: NANCY RANDALL**

LANDSCAPE ARCHITECT: **DESIGN WORKSHOP 301 NORTH WEST STREET** SUITE 109 RALEIGH, NC 27603 919.973.6254 CONTACT: BENJAMIN BOYD

REVISIONS	DATE
Resubmission	9/30/2022
	I

SITE PLAN APPLICATION 4TH ELECTION DISTRICT MONTGOMERY COUNTY, MARYLAND WSSC GRID: 216NW06 TAX MAP:GQ63

PAVEMENT MARKING & SIGNAGE PLAN **COVER SHEET**

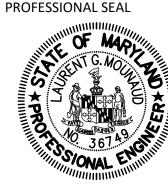

I HEREBY CERTIFY THAT THESE DOCUMENTS WERE **DULY LICENSED PROFESSIONAL ENGINEER UNDER** THE LAWS OF THE STATE OF MARYLAND.
NAME: LAURENT G. MOUNAUD LICENSE No.: 36749 EXPIRATION DATE: JANUARY 21, 2023


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DRAWN BY: DESIGNED BY: JAE DATE ISSUED: 11/12/2021

VM50024 PROJECT DRAWING

SHEET NO. PMS 1 OF 3



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HINES CONCEPTUAL

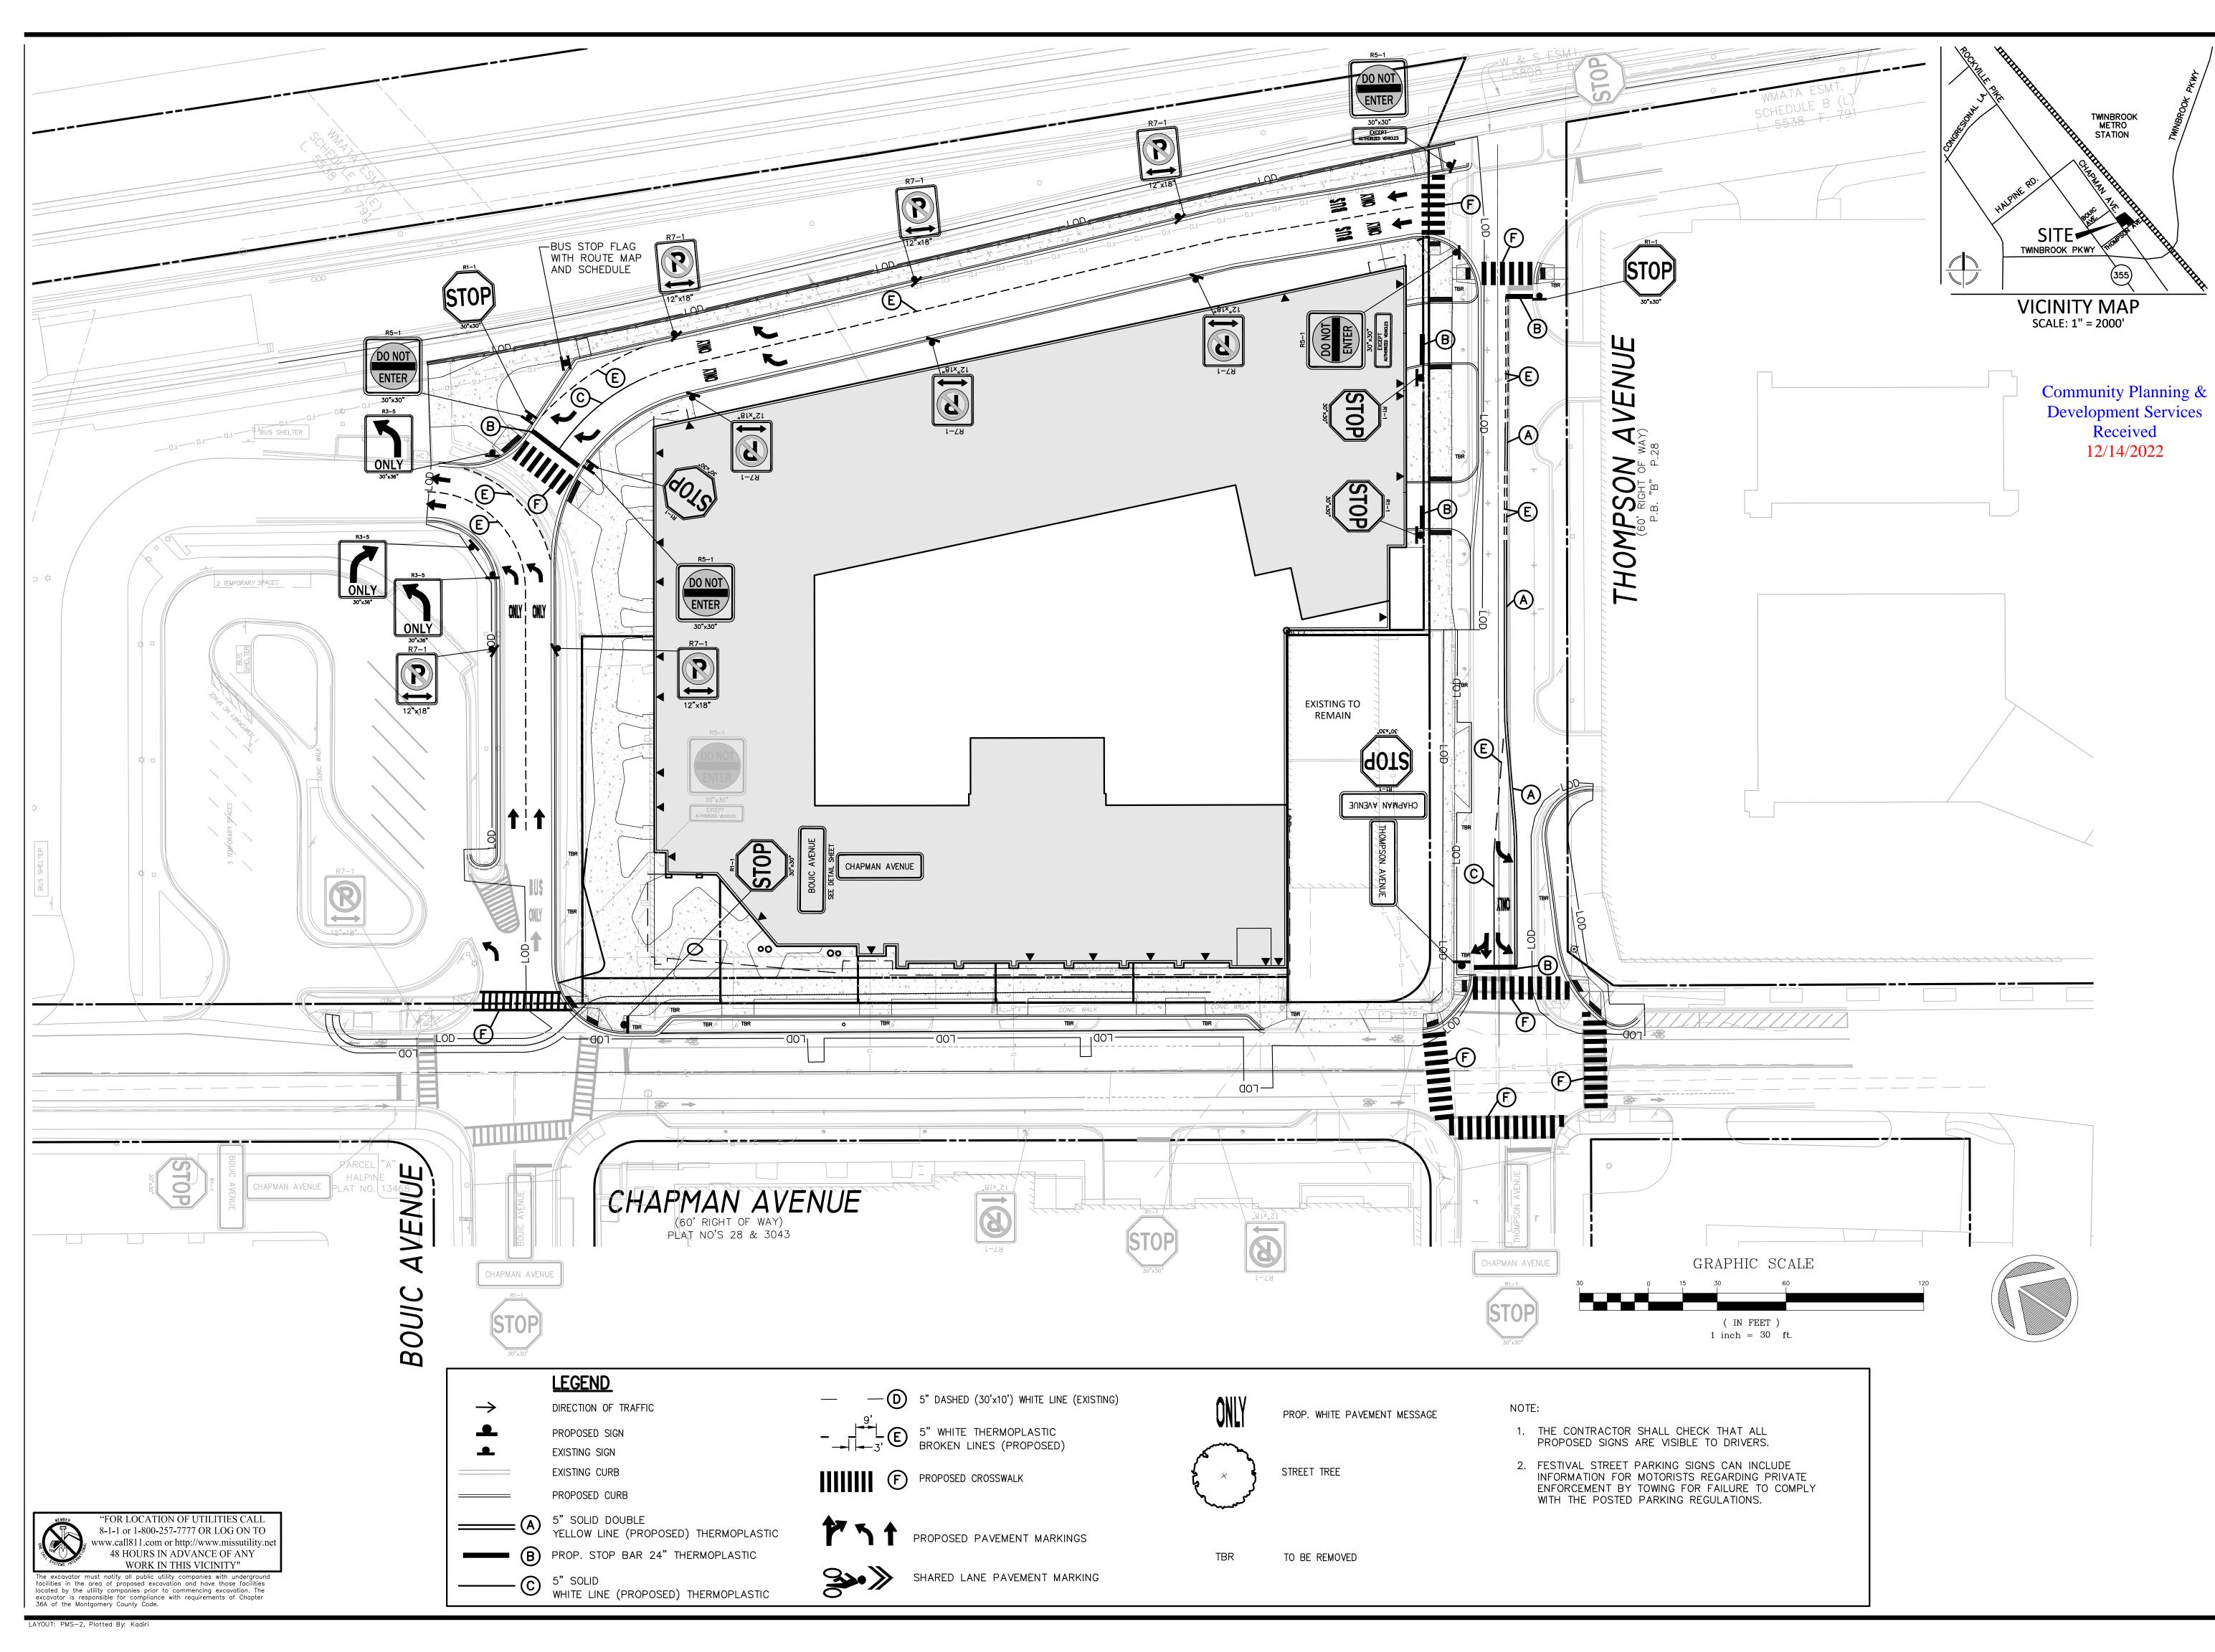CONSTRUCTION GROUP

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TRAFFIC:
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SUITE 210
SILVER SPRING, MD 20910
301.448.1333

LANDSCAPE ARCHITECT:

DESIGN WORKSHOP
301 NORTH WEST STREET
SUITE 109
RALEIGH, NC 27603
919.973.6254
CONTACT: BENJAMIN BOYD

CONTACT: NANCY RANDALL

REVISIONS	DATE
Resubmission	9/30/2022

1800 CHAPMAN

SITE PLAN
APPLICATION
4TH ELECTION DISTRICT
MONTGOMERY COUNTY,
MARYLAND
WSSC GRID: 216NW06
TAX MAP:GQ63

PAVEMENT MARKING & SIGNAGE PLAN



I HEREBY CERTIFY THAT THESE DOCUMENTS WERE PREPARED OR APPROVED BY ME, AND THAT I AM A DULY LICENSED PROFESSIONAL ENGINEER UNDER THE LAWS OF THE STATE OF MARYLAND. NAME: LAURENT G. MOUNAUD LICENSE NO.: 36749
EXPIRATION DATE: JANUARY 21, 2023


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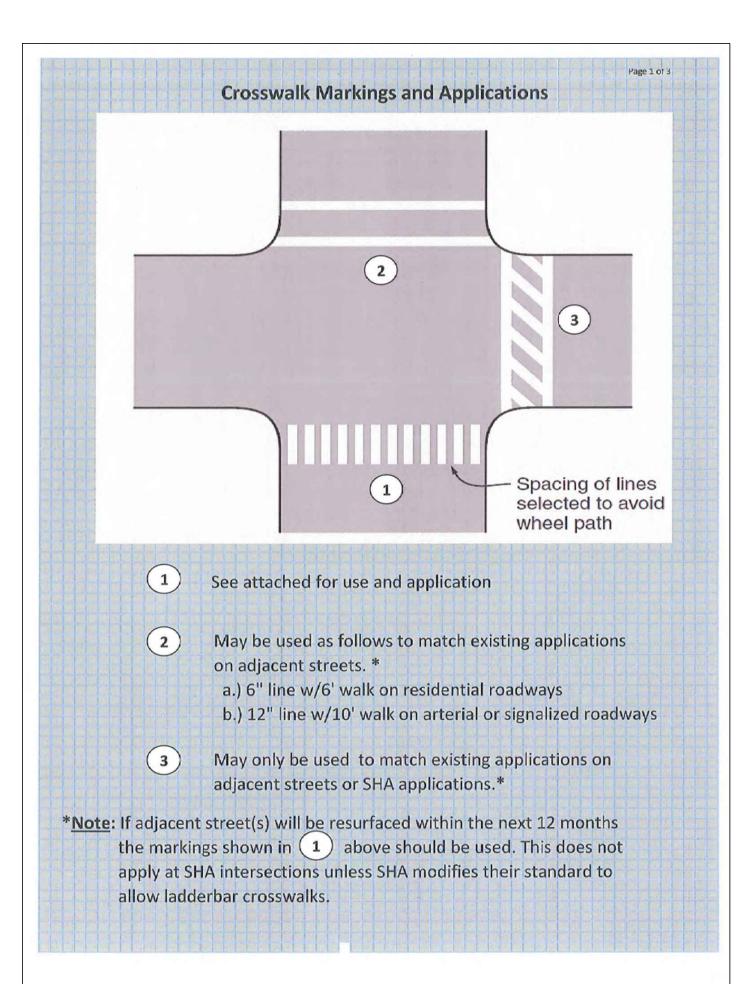
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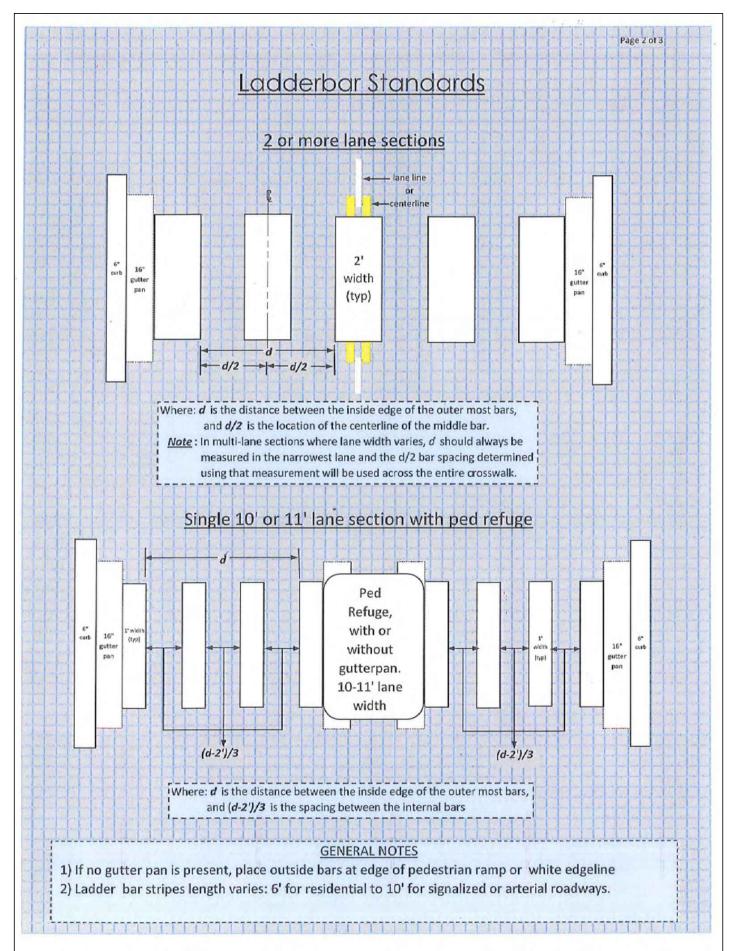
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DATE ISSUED: 11/12/2021


PROJECT VM50024
DRAWING

SHEET NO. PMS 2 OF 3







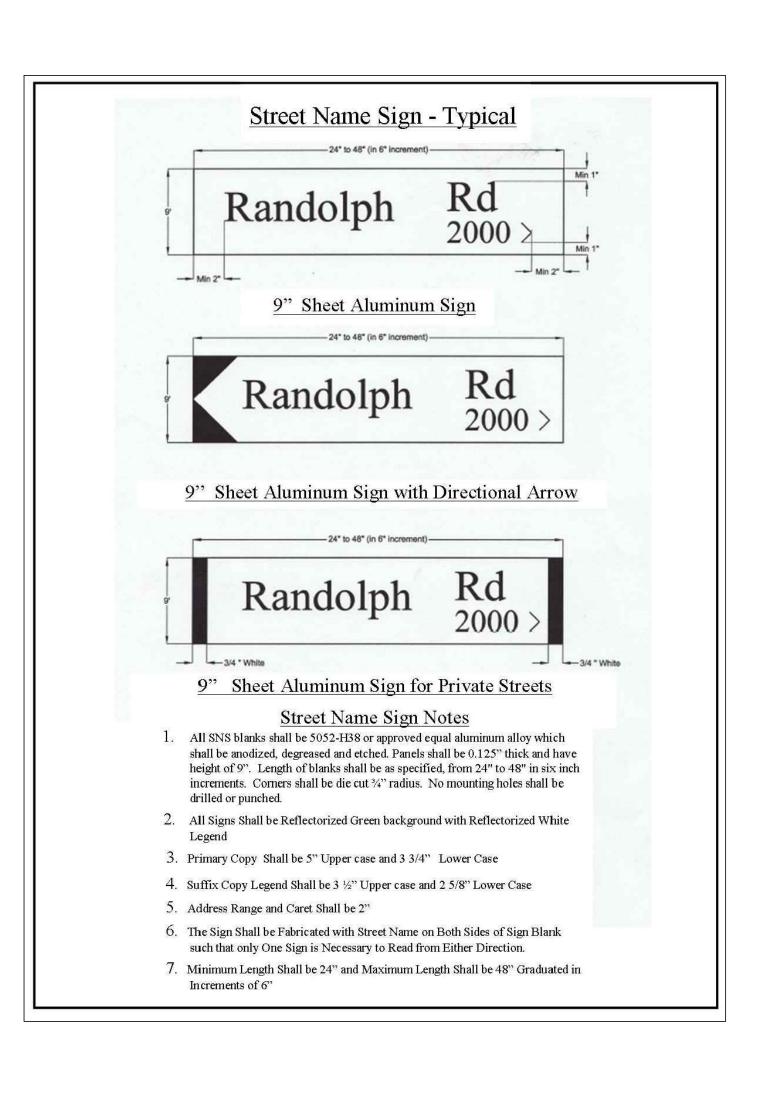


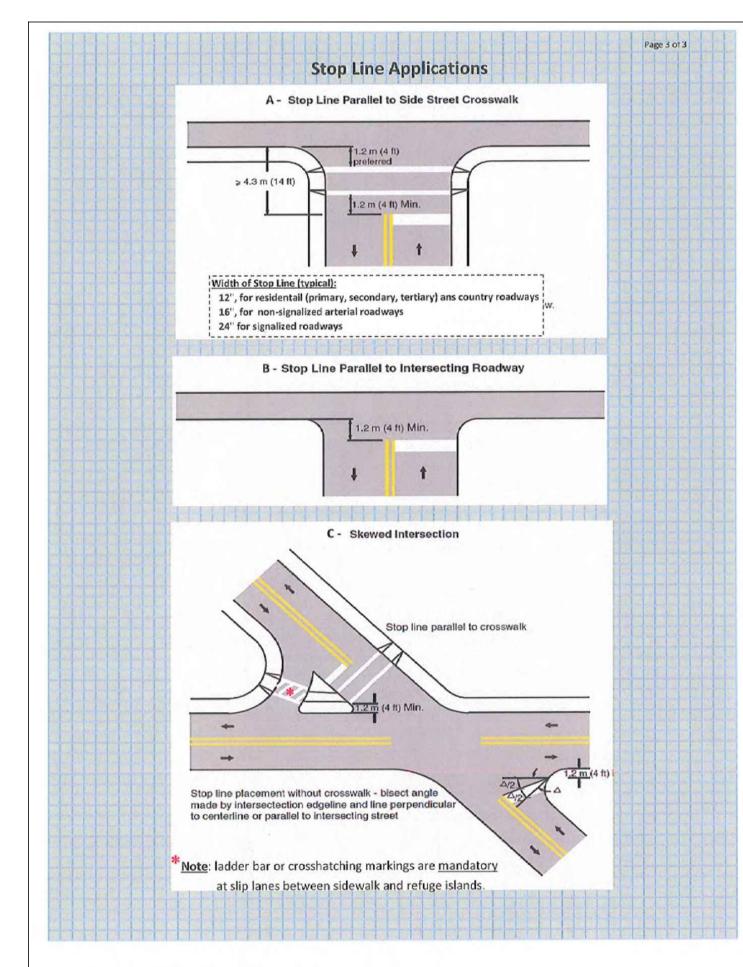



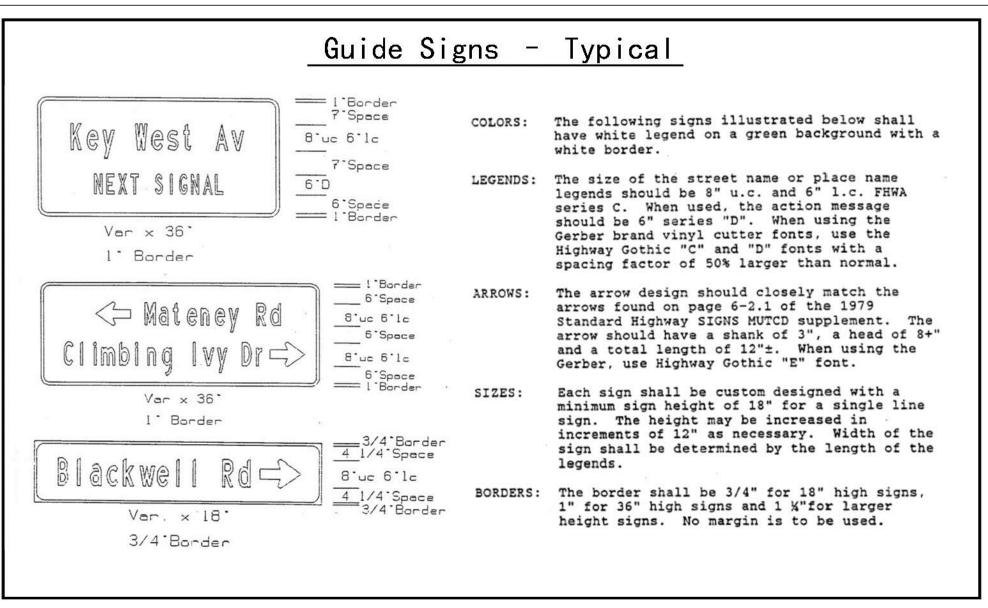

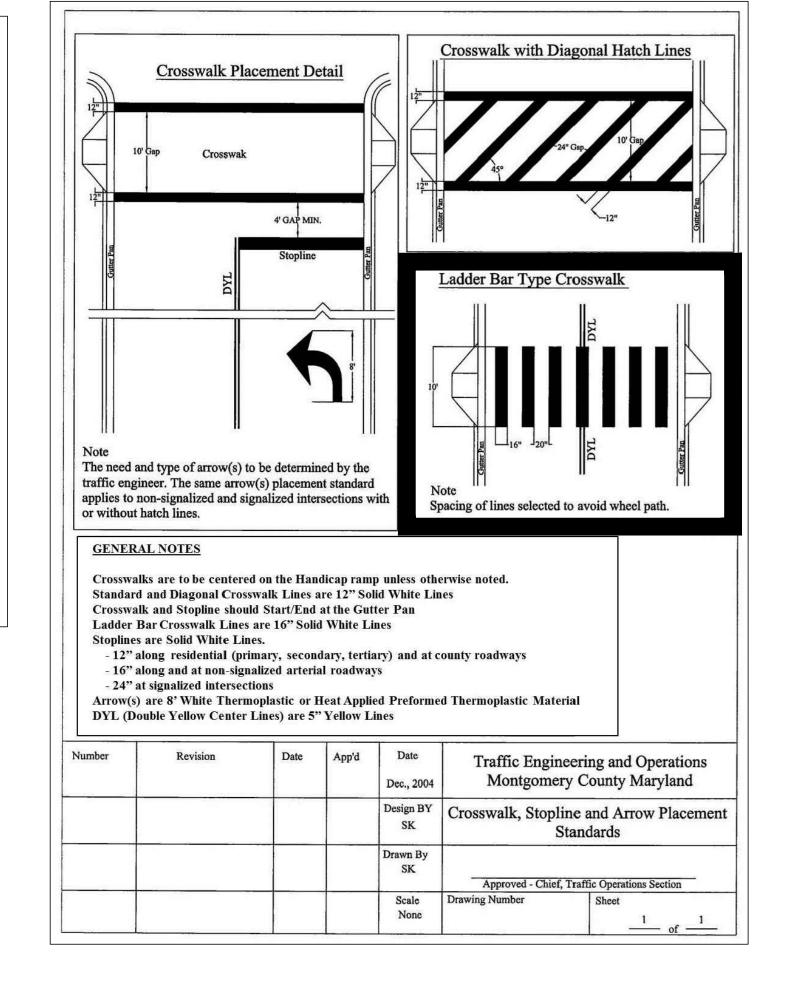

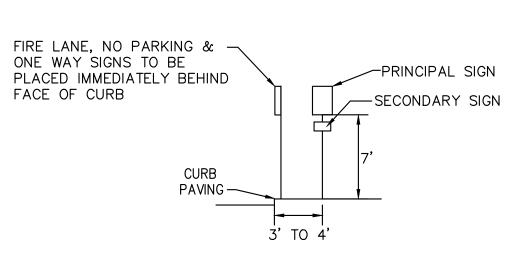

TYPICAL SIGN PLACEMENT DETAIL



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REVISIONS	DATE
Resubmission	9/30/2022

1800 **CHAPMAN**

SITE PLAN APPLICATION 4TH ELECTION DISTRICT MONTGOMERY COUNTY, MARYLAND WSSC GRID: 216NW06 TAX MAP:GQ63

PAVEMENT MARKING & SIGNAGE DETAILS



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DRAWN BY: DESIGNED BY: _ JAE DATE ISSUED: 11/12/2021

PROJECT

VM50024 DRAWING

SHEET NO. PMS 3 OF 3

"FOR LOCATION OF UTILITIES CALL 8-1-1 or 1-800-257-7777 OR LOG ON TO www.call811.com or http://www.missutility.net 48 HOURS IN ADVANCE OF ANY WORK IN THIS VICINITY" The excavator must notify all public utility companies with underground facilities in the area of proposed excavation and have those facilities located by the utility companies prior to commencing excavation. The excavator is responsible for compliance with requirements of Chapter 36A of the Montgomery County Code.

GENERAL NOTES

- 1. The provided survey has been reformatted for use in and for preparation of these documents. Contractor shall obtain officially signed copy of the survey and become familiar with it, the existing conditions and site context prior to construction. All discrepancies should be brought to the attention of the Landscape Architect for immediate resolution. Landscape Architect is not responsible for errors or omissions associated with preparation or documentation of survey.
- 2. Contractor is responsible for determining means and methods for construction. These drawings may indicate a limit of proposed improvements, limits of site demolition, etc. for delineation of expected extents of disturbance, however, final impact shall be determined in the field. Should limits of disturbance exceed boundaries defined in drawings, Contractor shall contact Landscape Architect for resolution.
- 3. Contractor is responsible for repairing all work disturbed by construction outside of limit lines defined on drawings or through his/her means and methods and General Conditions to a condition acceptable to the owner at no additional cost.
- 4. Contractor is responsible for protecting all existing conditions, improvements, utilities, etc. to remain. Any damages shall be repaired to a condition acceptable to the owner at no additional cost.
- 5. Contractor is responsible for maintaining a complete up-to-date set of Drawings and Specifications at the construction site and ensuring the documents are readily available for review by the Landscape Architect and governing agency.
- 6. The Drawings and Specifications are complementary to one another and implied to correspond with one another. Any discrepancies should be brought to the attention of the Landscape Architect for immediate
- 7. Contact the local underground utility service locator for utility locates and identification prior to commencing work and maintain in field throughout construction unless indicated or directed otherwise.
- 8. Verify plant protection, stormwater pollution protection plan (SWPPP), existing improvement to remain, and Contractor site control measures are in place prior to commencing with construction. Do not proceed with construction if not in compliance and maintained throughout. Coordinate with Owner's Representative and authorities having jurisdiction as required.

SITE LAYOUT NOTES

- 1. Layout and dimensions provided on Drawings are based on architecture building grid.
- Verify utility locates, plant protection and stormwater pollution protection plan (SWPPP) measures are in place
 prior to commencing construction. Do not proceed with construction if not in compliance and maintained
 throughout.
- 3. Layout and verify dimensions prior to construction. Field stake all proposed improvements for review and approval by Landscape Architect unless indicated otherwise. Bring discrepancies to the attention of the Landscape Architect for final direction. Landscape Architect reserves right to make field adjustments and layout decisions in field as necessary at no additional cost to owner.
- Request inspection of field staking by Landscape Architect a minimum of 24 hours in advance of performing any work unless indicated otherwise.
- 5. For dimensions of buildings, garages, trash enclosures, and related work, refer to the architectural drawings. Copies of these drawings are available from the owner.
- 6. Written dimensions take precedence over scaled dimensions. Bring discrepancies to the attention of the
- Landscape Architect for final direction.
- 7. Where dimensions are called as "equal," space referenced items equally, measured to their center lines.8. Measurements are to face of building, wall or the fixed site improvement. Dimensions to center lines is indicated.

Typical Specific Measurement Guidelines:

- 9. Expansion joints in walkways shall be located at (30'-0") on center maximum unless indicated otherwise.
- 10. "All" steps shall have (12") treads unless indicated otherwise.
- 11. "All" stairway perimeter handrails shall extend 12" beyond top riser, 12" beyond bottom riser, and be set 2" clear from edge of (stairs) (wall) unless indicated otherwise. Intermediate handrails shall be as indicated.
- 12. All accessible ramps shall be 5'-0" clear unless designated otherwise.
- 13. All accessible ramp handrails shall extend 12" beyond top of ramp and 12" beyond bottom of ramp, and be set 2" clear from edge of paving or wall unless designated otherwise.

SITE GRADING AND DRAINAGE NOTES

- Protect existing utilities to remain. Contractor is responsible for all damage to utilities encountered during construction and shall repair at no additional cost to owner.
- 2. Layout and field stake all proposed landscape grading and drainage improvements for review and approval by Landscape Architect prior to construction unless indicated or directed otherwise.
- 3. Request inspection of field staking by Landscape Architect a minimum of 24 hours in advance of performing any work unless indicated otherwise.
- 4. Landscape spot elevations shall be as indicated and defined per Abbreviations List. Bring any discrepancies to attention of Landscape Architect for clarification.
- 5. Provide a minimum of 1% (1:100) slope and a maximum of 5% (1:20) slope on all proposed hardscape and minimum of 2% (1:50) slope and maximum of 33% (1:3) slope on all proposed softscape unless indicated otherwise.
- 6. All surfaces shall be flush and meet smoothly and evenly unless indicated otherwise.
- 7. Provide positive drainage and pitch to drain.
- 8. Refer to Civil Engineer's drawings for all design calculations, details, subsurface piping, overflows/ outfalls, storage basins, erosion control, stormwater pollution protection plans (SWPPP) and connections to site landscape and hardscape drains indicated in drawings unless designated otherwise.
- 9. Provide erosion control measures for swales exceeding 5% (1:20) slope and grades/hillsides exceeding 33% (1:3) slope as indicated. If not indicated bring to the attention of Landscape Architect immediately for direction.
- 10. Refer to Civil Engineer's drawings for all roadway and driveway improvements.
- 11. Refer to MEP drawings for all design calculations, details, piping and connections to landscape and hardscape drains over structure
- 12. Refer to architectural drawings for waterproofing of building and site structure slab penetrations for landscape stormwater drains and piping.

SITE SOILS NOTES


- Contractor shall coordinate with Owner's Representative for location of stockpile areas for stripped topsoil and planting soil products. Contractor shall ensure area is protected and contamination or disturbance of stored products is not allowed.
- 2. Contractor shall ensure subgrade is scarified prior to installing planting soil and blend with initial lift or placement of proposed planting soil.
- 3. Coordinate placement of planting soil with other work, especially utilities. Placement should occur after installation of all hardscape improvements, irrigation system, utilities, etc. and before installation of plants.

LANDSCAPE PLANTING NOTES


- 1. Refer to Civil Engineer's utility and grading and drainage plans as required. If actual site conditions vary from what is shown on the plans, contact the Landscape Architect for direction as to how to proceed.
- 2. Verify locations of pertinent site improvements installed under other sections. If any part of this plan cannot be followed due to site conditions, contact Landscape Architect for instructions prior to commencing work.
- 3. Exact locations of plant materials shall be approved by the Landscape Architect in the field prior to installation. Stake or otherwise layout all proposed planting for review. Landscape Architect reserves the right to adjust plants to exact location in field.
- 4. Verify plant counts and square footages. Quantities are provided as Owner information only. If quantities on plant list differ from graphic indications, then graphics shall prevail. If graphics are inconclusive contact Landscape Architect for clarification.
- 5. Perform excavation in vicinity of underground utilities and existing tree/plant driplines with care and if necessary, by hand. The Contractor bears full responsibility for this work and disruption or damage to utilities and existing trees/plants shall be repaired or replaced immediately at no expense to the Owner.
- 6. Trees/plants shall bear same relation to finished grade as it bore to existing in place of growth. However, at no point shall it be less than 1 inch above adjacent finish grade.
- 7. Trees shall be planted a minimum of 10 feet from face of building and a minimum of 3 feet from edge of pavement, except as approved by Landscape Architect.
 8. Shrubs shall be planted a minimum of 3 feet from face of building and a minimum of 12 inches from edge of pavement, except as approved by Landscape Architect.
- 9. All other plants (perennials, grasses, groundcover, annuals) shall be planted a minimum of 12 inches from face of building and a minimum of 6 inches from edge of pavement, except as approved by Landscape Architect.
- 10. Provide matching forms and sizes for plant materials within each species and size designated on the drawings.
- 11. Prune newly planted trees only as directed by Landscape Architect.
- 12. Finish grades of planting areas and lawns shall be flush and meet smoothly and evenly with adjacent paving, providing positive drainage. Shovel V-cut edges shall be provided at planting area transitions to adjacent pavement as indicated to allow for mulch installation.
- 13. Provide specified edging as divider between planting beds and lawn areas.

CALLOUT SAMPLES

SAMPLE KEYNOTE DRAWING CALLOUT:

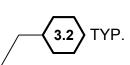

SITE DETAIL KEYNOTES: DETAIL/ RELATED SPEC. SHEET DETAIL(S) SECTION(S)

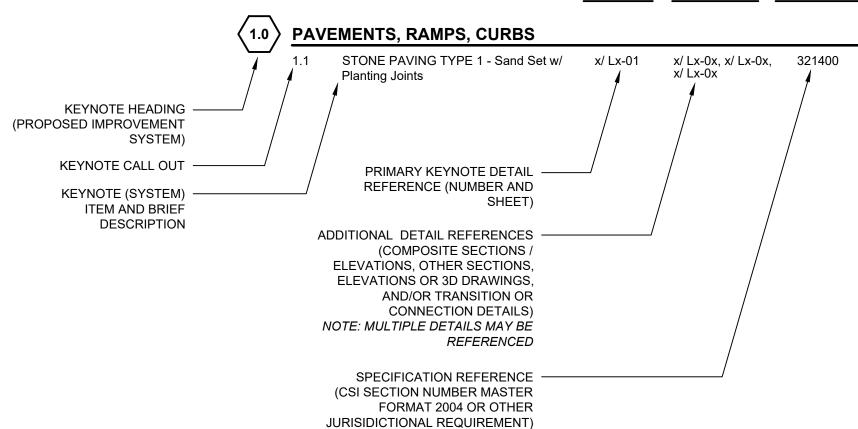


NOTE: MULTIPLE

REFERENCED

SPECIFICATIONS MAY BE


SAMPLE REFERENCE NOTE KEY:

PLANT IDENTIFICATION KEY:

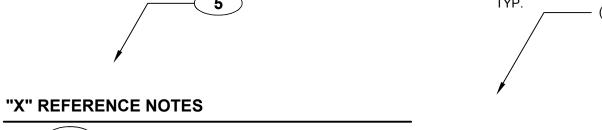

final location of path to be determined in field under direction of Landscape Architect.

NOTE: "X" REFERS TO DRAWING SERIES (i.e. SITE DEMOLITION REFERENCE NOTES). THERE SHOULD BE SPECIFIC REFERENCE NOTES FOR EACH DRAWING SERIES. HOWEVER, SOME NOTES MAY APPEAR ON MULTIPLE SERIES AS APPLICABLE.

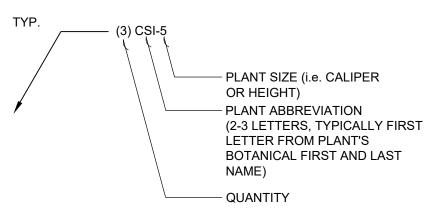

NOTE: PLANT ABBREVIATION ON PLANT IDENTIFICATION KEY SHOULD CORRESPOND WITH ABBREVIATION ON PLANT LIST (i.e. CSI-5 SHOULD REFER TO A CORNUS SERICEA 'ISANTI', 5 GALLON CONTAINER)

LIST OF ABBREVIATIONS

MEMBRANE

MEMB

LIGI OI	ADDICEVIATIONS		
APPROX	APPROXIMATE	MH	MANHOLE
ARCH	ARCHITECT	MIN	MINIMUM
AVG	AVERAGE	MISC	MISCELLANEOUS
3&B	BALLED AND BURLAPPED	MTD	MOUNTED
3C	BOTTOM OF CURB	MTL	METAL
3F	BOTTOM OF FOOTING	N	NORTH
BLDG	BUILDING	NIC	NOT IN CONTRACT
BM	BENCHMARK	NO	NUMBER
BOC	BACK OF CURB	NOM	NOMINAL
3R	BOTTOM OF RAMP	NTS	NOT TO SCALE
BRG	BEARING	OC	
			ON CENTER
BS	BOTTOM OF STEP	OD	OUTSIDE DIAMETER
ВW	BOTTOM OF WALL	OPP	OPPOSITE
CAL	CALIPER	PAR	PARALLEL
CAP	CAPACITY	PC	POINT OF CURVATURE
CF	CUBIC FEET	PE	POLYURETHANE
CHAM	CHAMFER	PERF	PERFORATED
CIP	CAST IN PLACE	PED	PEDESTRIAN
J	CONTROL JOINT	PI	POINT OF INTERSECTION
CL	CENTER LINE	PL	PROPERTY LINE
CLR	CLEARANCE	PT	POINT, POINT OF TANGENCY
CM	CENTIMETER	PVC	POLYVINYL CHLORIDE
00	CLEAN OUT	PVMT	PAVEMENT
COMP	COMPACTED	PVR	
			PAVER
CONC	CONCRETE	QTY	QUANTITY
CONST	CONSTRUCTION	R	RADIUS
CONT	CONTINUOUS	RECEP	RECEPTACLE
CONTR	CONTRACTOR	REF	REFERENCE
CU	CUBIC	REINF	REINFORCE(D)
CY	CUBIC YARD	REM	REMOVE
DBL	DOUBLE	REQ'D	REQUIRED
OF .	DIRECTION OF FLOW	REV	REVISION, REVISED
DEG	DEGREE	ROW	RIGHT OF WAY
DEMO	DEMOLISH, DEMOLITION	RT	RIGHT
DIA	DIAMETER	S	SOUTH
DIM	DIMENSION	SAN	SANITARY
)TL	DETAIL	SCH	SCHEDULE
DWG	DRAWING	SD	STORM DRAIN
<u> </u>	EAST	SEC	SECTION
Α	EACH	SF	SQUARE FOOT (FEET)
J	EXPANSION JOINT	SHT	SHEET
Ĺ	ELEVATION	SI	STORM INLET
LEC	ELECTRICAL	SIM	SIMILAR
NG	ENGINEER	SNT	SEALANT
.Q	EQUAL	SPECS	SPECIFICATIONS
QUIP	EQUIPMENT	SQ	SQUARE
ST	ESTIMATE	ST	STORM SEWER
.W.	EACH WAY	SY	SQUARE YARD
XIST	EXISTING	STA	STATION
XP	EXPANSION, EXPOSED	STD	STANDARD
F	FINISHED FLOOR ELEVATION	STL	STEEL
G	FINISHED GRADE	STRL	STRUCTURAL
IN	FINISH	SYM	SYMMETRICAL
L	FLOW LINE	T&B	TOP AND BOTTOM
OC	FACE OF CURB	TBC	TOP OF BACK CURB
-T	FOOT (FEET)	TC	TOP OF CURB
TG	FOOTING	TF	TOP OF CORB TOP OF FOOTING
GA.	GAUGE	THK	THICK
GAL	GALVANIZED	TOC	TOP OF CONCRETE
GC .	GENERAL CONTRACT(OR)	TOPO	TOPOGRAPHY
GEN	GENERAL	TSL	TOP OF SLAB
IORIZ	HORIZONTAL	TRAS	TRANSFORMER
1P		TR	TOP OF RAMP
	HIGH POINT		
I T	HEIGHT	TS	TOP OF STEP
)	INSIDE DIAMETER	TW	TOP OF WALL
NV	INVERT ELEVATION	TYP	TYPICAL
N	INCH(ES)	VAR	VARIES
NCL	INCLUDE(D)	VERT	VERTICAL
	` '		
NL	INLET	VEH	VEHICLE
RR	IRRIGATION	VOL	VOLUME
IT	JOINT	W/	WITH
.IN	LINEAR	W/O	WITHOUT
.F	LINEAR FEET	WT	WEIGHT
LP	LOW POINT	WL	WEIR LEVEL
LT LT	LIGHT	WWF	WELDED WIRE FABRIC
MATL	MATERIAL	YD	YARD
MAX	MAXIMUM	@	AT
N A C N A C)	8 41 TADD A NIC		

Community Planning & Development Services Received 12/14/2022

700 E. Pratt St, Suite 1200 Baltimore, MD 21202 p. 410. 837. 7311 f. 410.837.6530 STRUCTURAL ENGINEER 1155 Connecticut Avenue, NW, Suite 800 Washington, DC 20036 p. 202.659.2520 M/E/P ENGINEER 37 W. Cross St, Suite 300 Baltimore, MD 21230 p. 443.602.9520 **CIVIL ENGINEER** VIKA MARYLAND, LLC 20251 Century Blvd, Suite 400 Germantown, MD 20874 p. 301.916.4100

LANDSCAPE ARCHITECT

DESIGN WORKSHOP

ARCHITECT

Hord Coplan Macht, Inc.

301 North West St, Suite 109 Raleigh, NC 27603 p. 919.973.6254 INTERIOR DESIGNER NILES BOLTON ASSOCIATES 3060 Peachtree Rd NW, Suite 600 Atlanta, GA 30305

HINES

p. 404.365.7600


TWINBROOK MULTIFAMILY

1800 CHAPMAN AVE, ROCKVILLE MD 20852

herd coplan macht



ARCHITECTURE

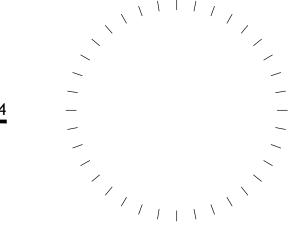

ı	I TROI EGGIONAL CERTII ICATION. I CERTII I THAT THESE DOCUMENTS WERE
ı	PREPARED OR APPROVED BY ME, AND THAT I AM A DULY LICENSED ARCHIT
ı	UNDER THE LAWS OF THE STATE OF MARYLAND
ı	LICENSE NUMBER:
ı	EXPIRATION DATE:
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no.	date	revision	
Project	Name		
TWIN	IBROOI	K MULTIFAMILY	
Project	Number		

Project Number
220252.00

Date
12.08.22

Scale

Drawing


GENERAL NOTES


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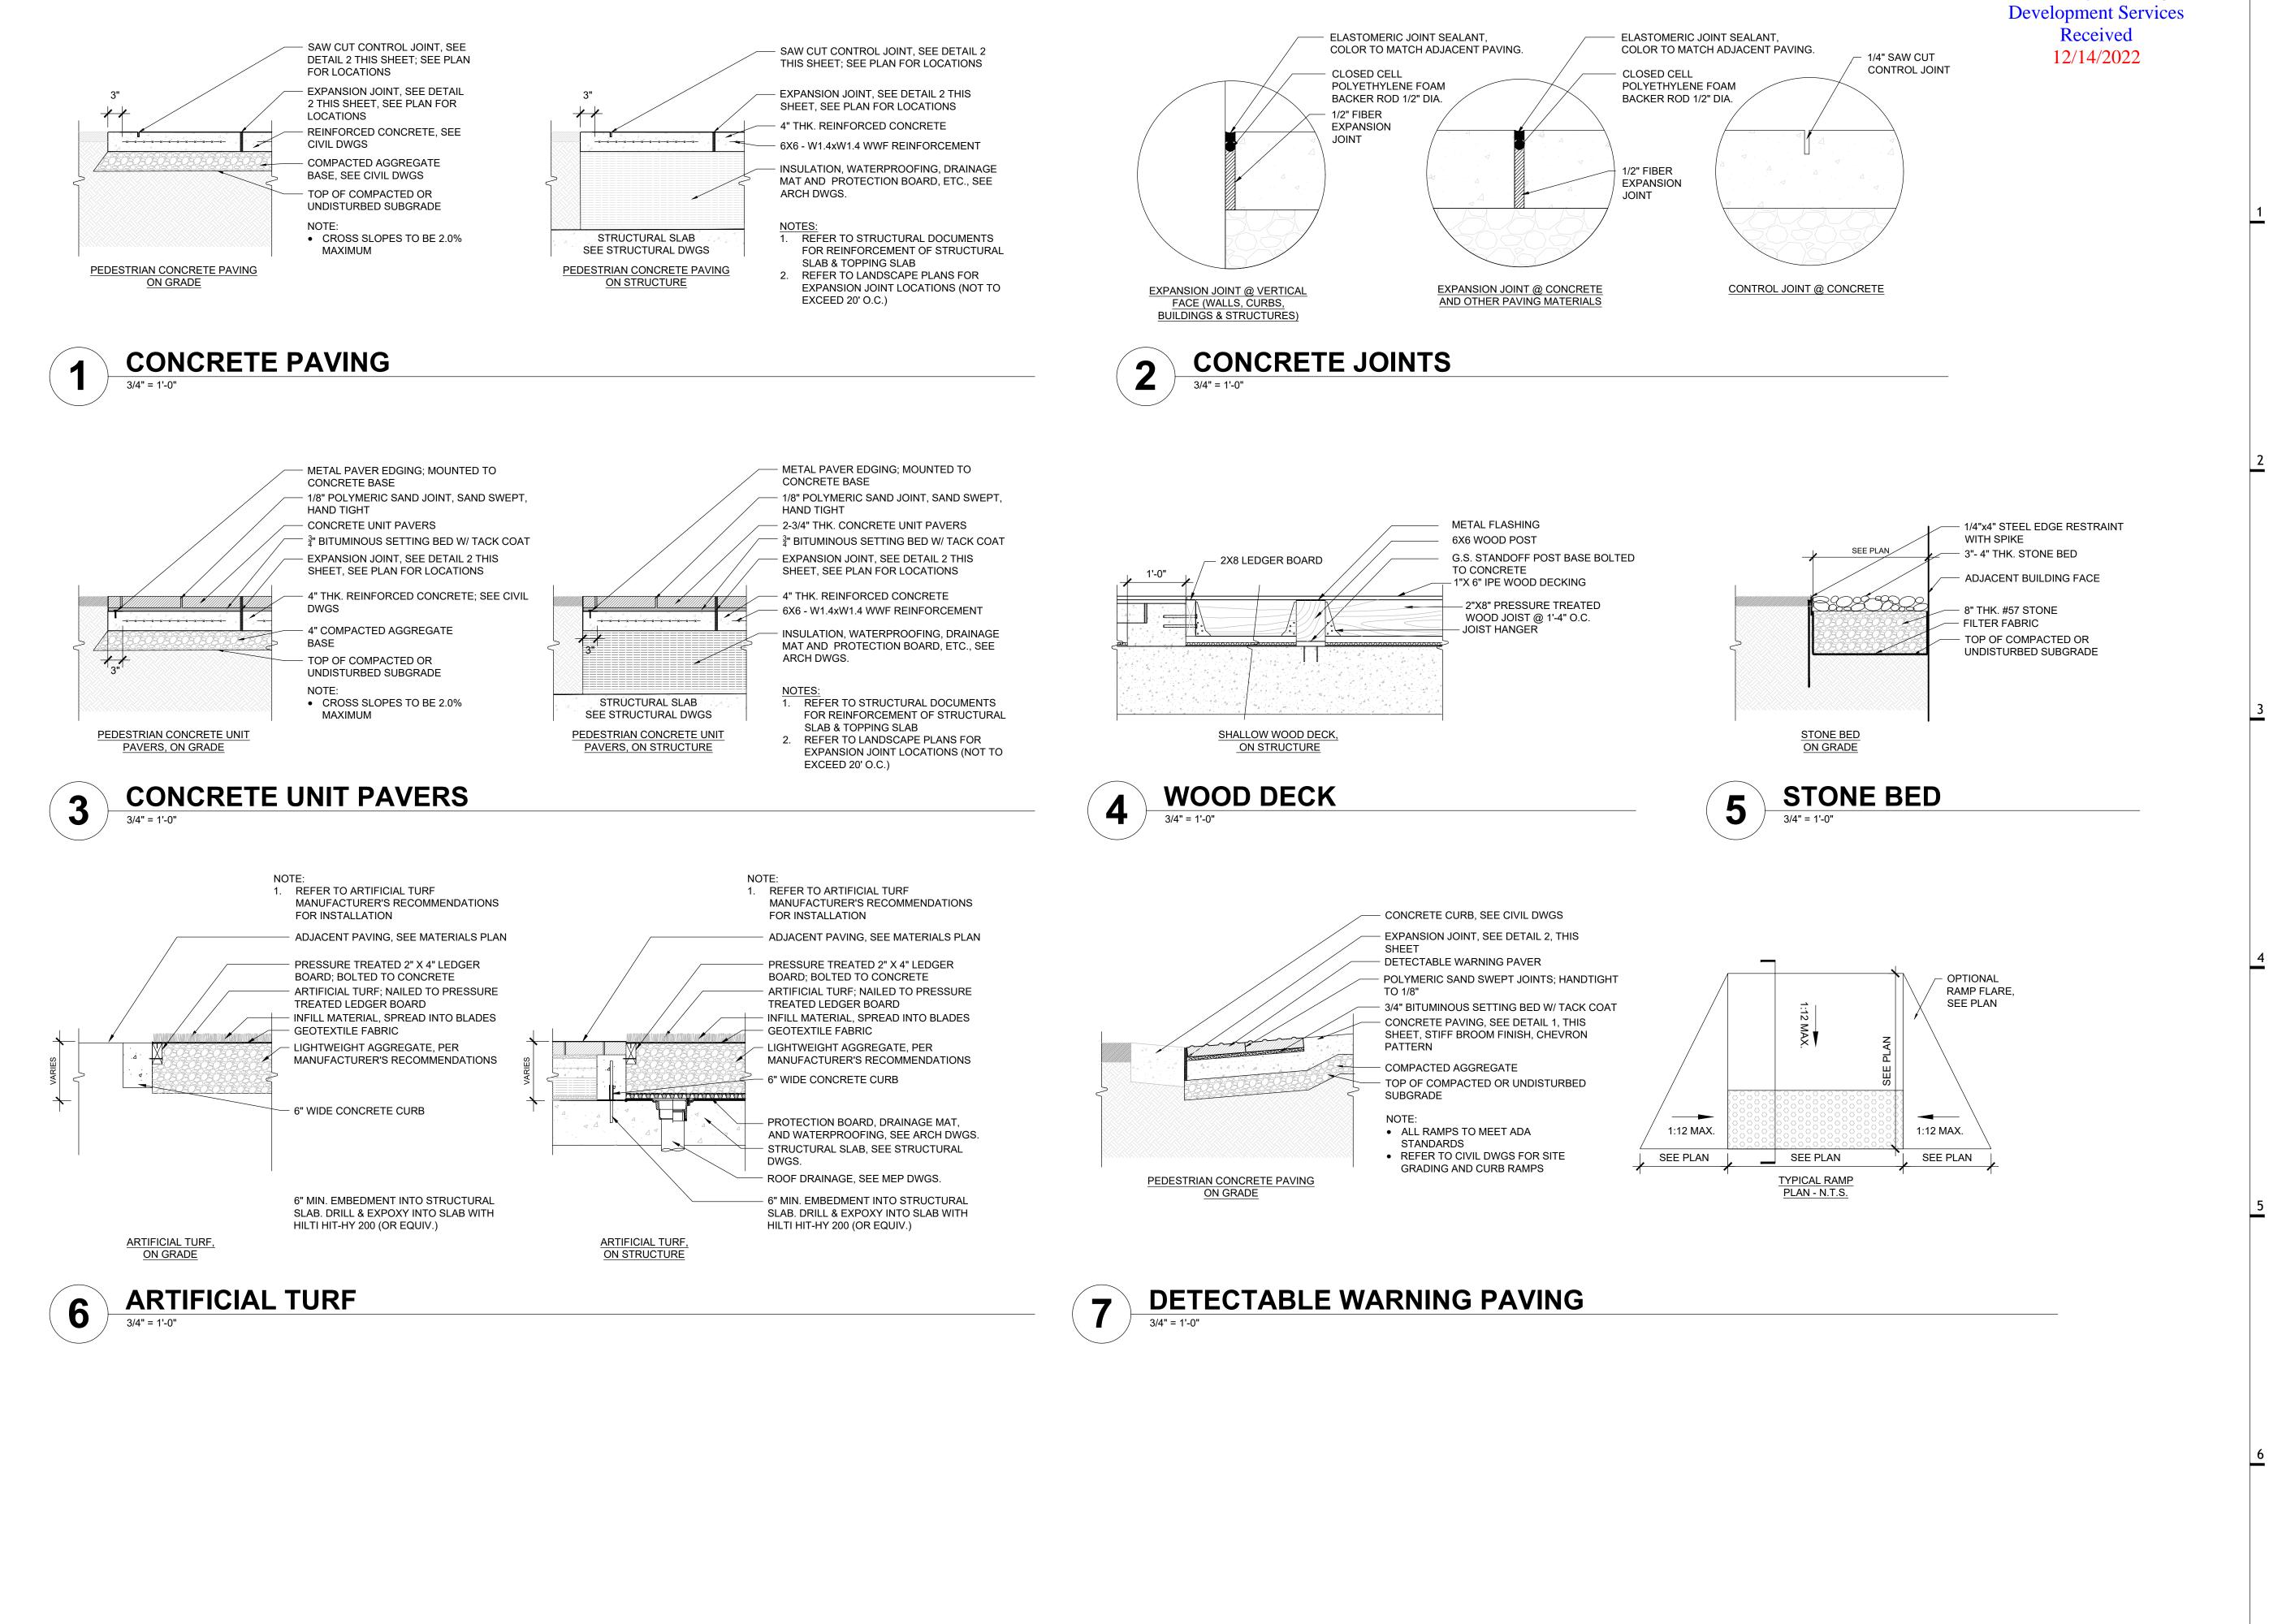
SITE PLAN SUBMISSION

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ARCHITECTURE LANDSCAPE ARCHITECTURE

PLANNING INTERIOR DESIGN

ARCHITECT

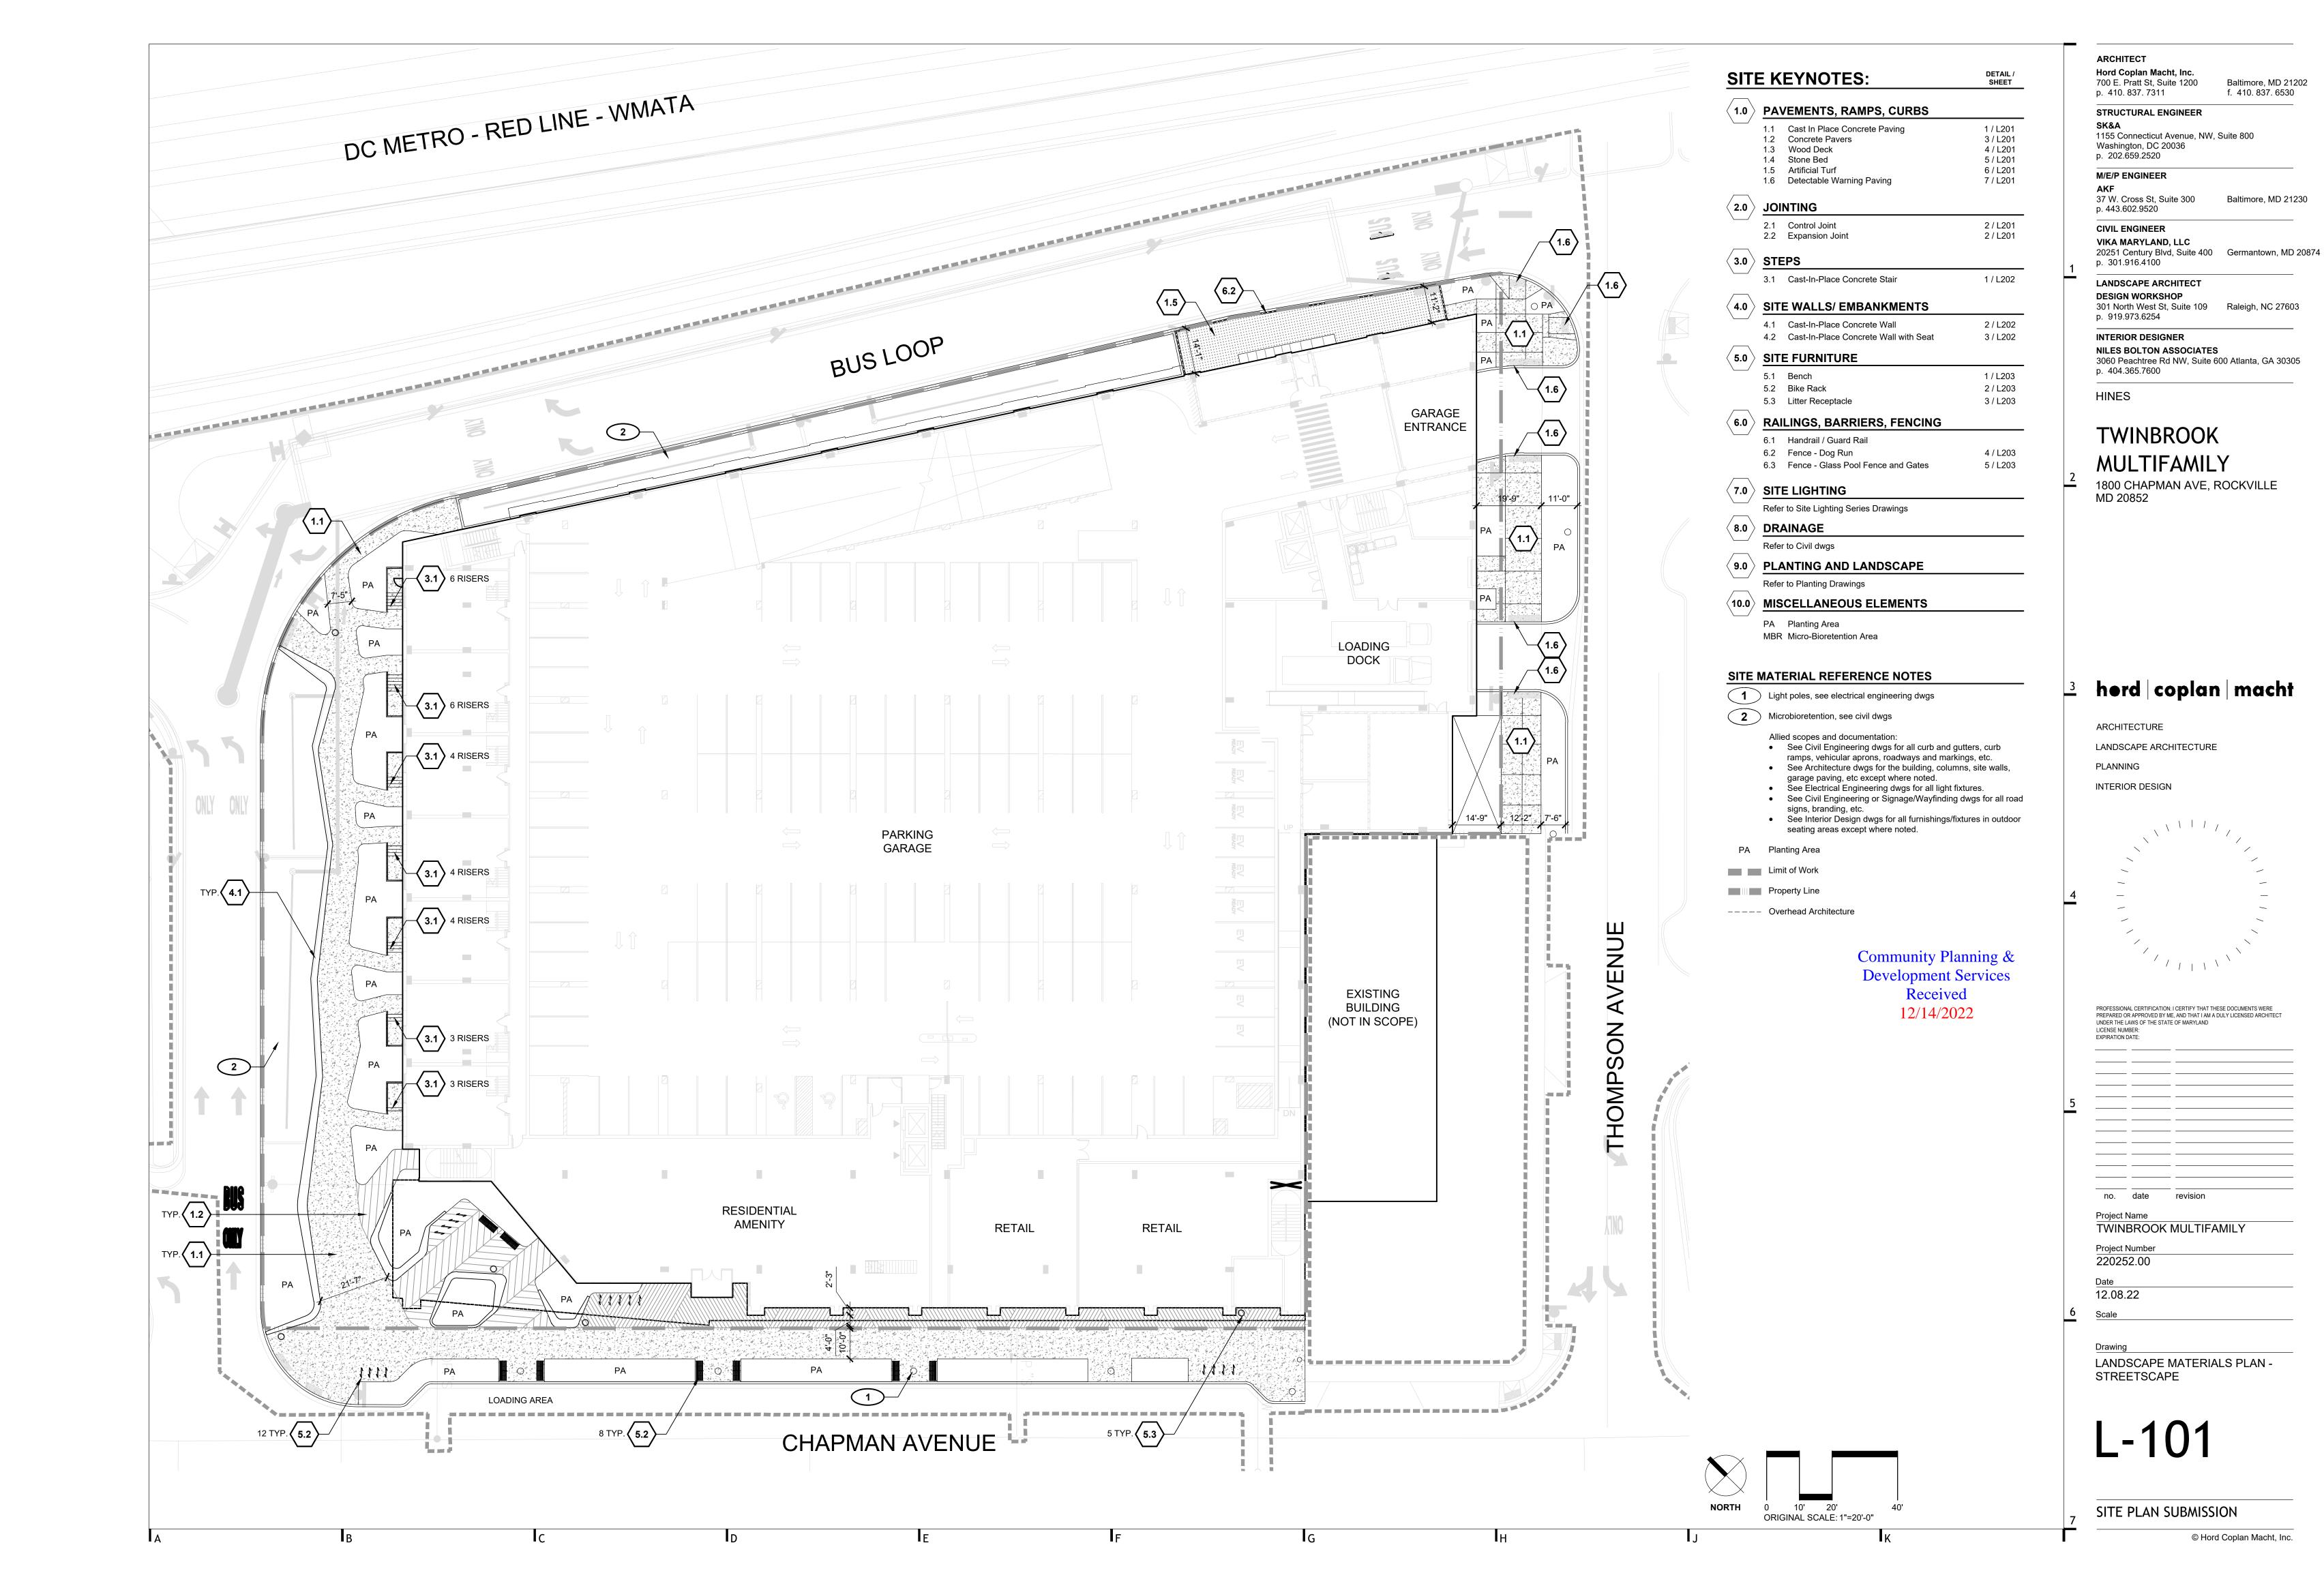p. 410. 837. 7311
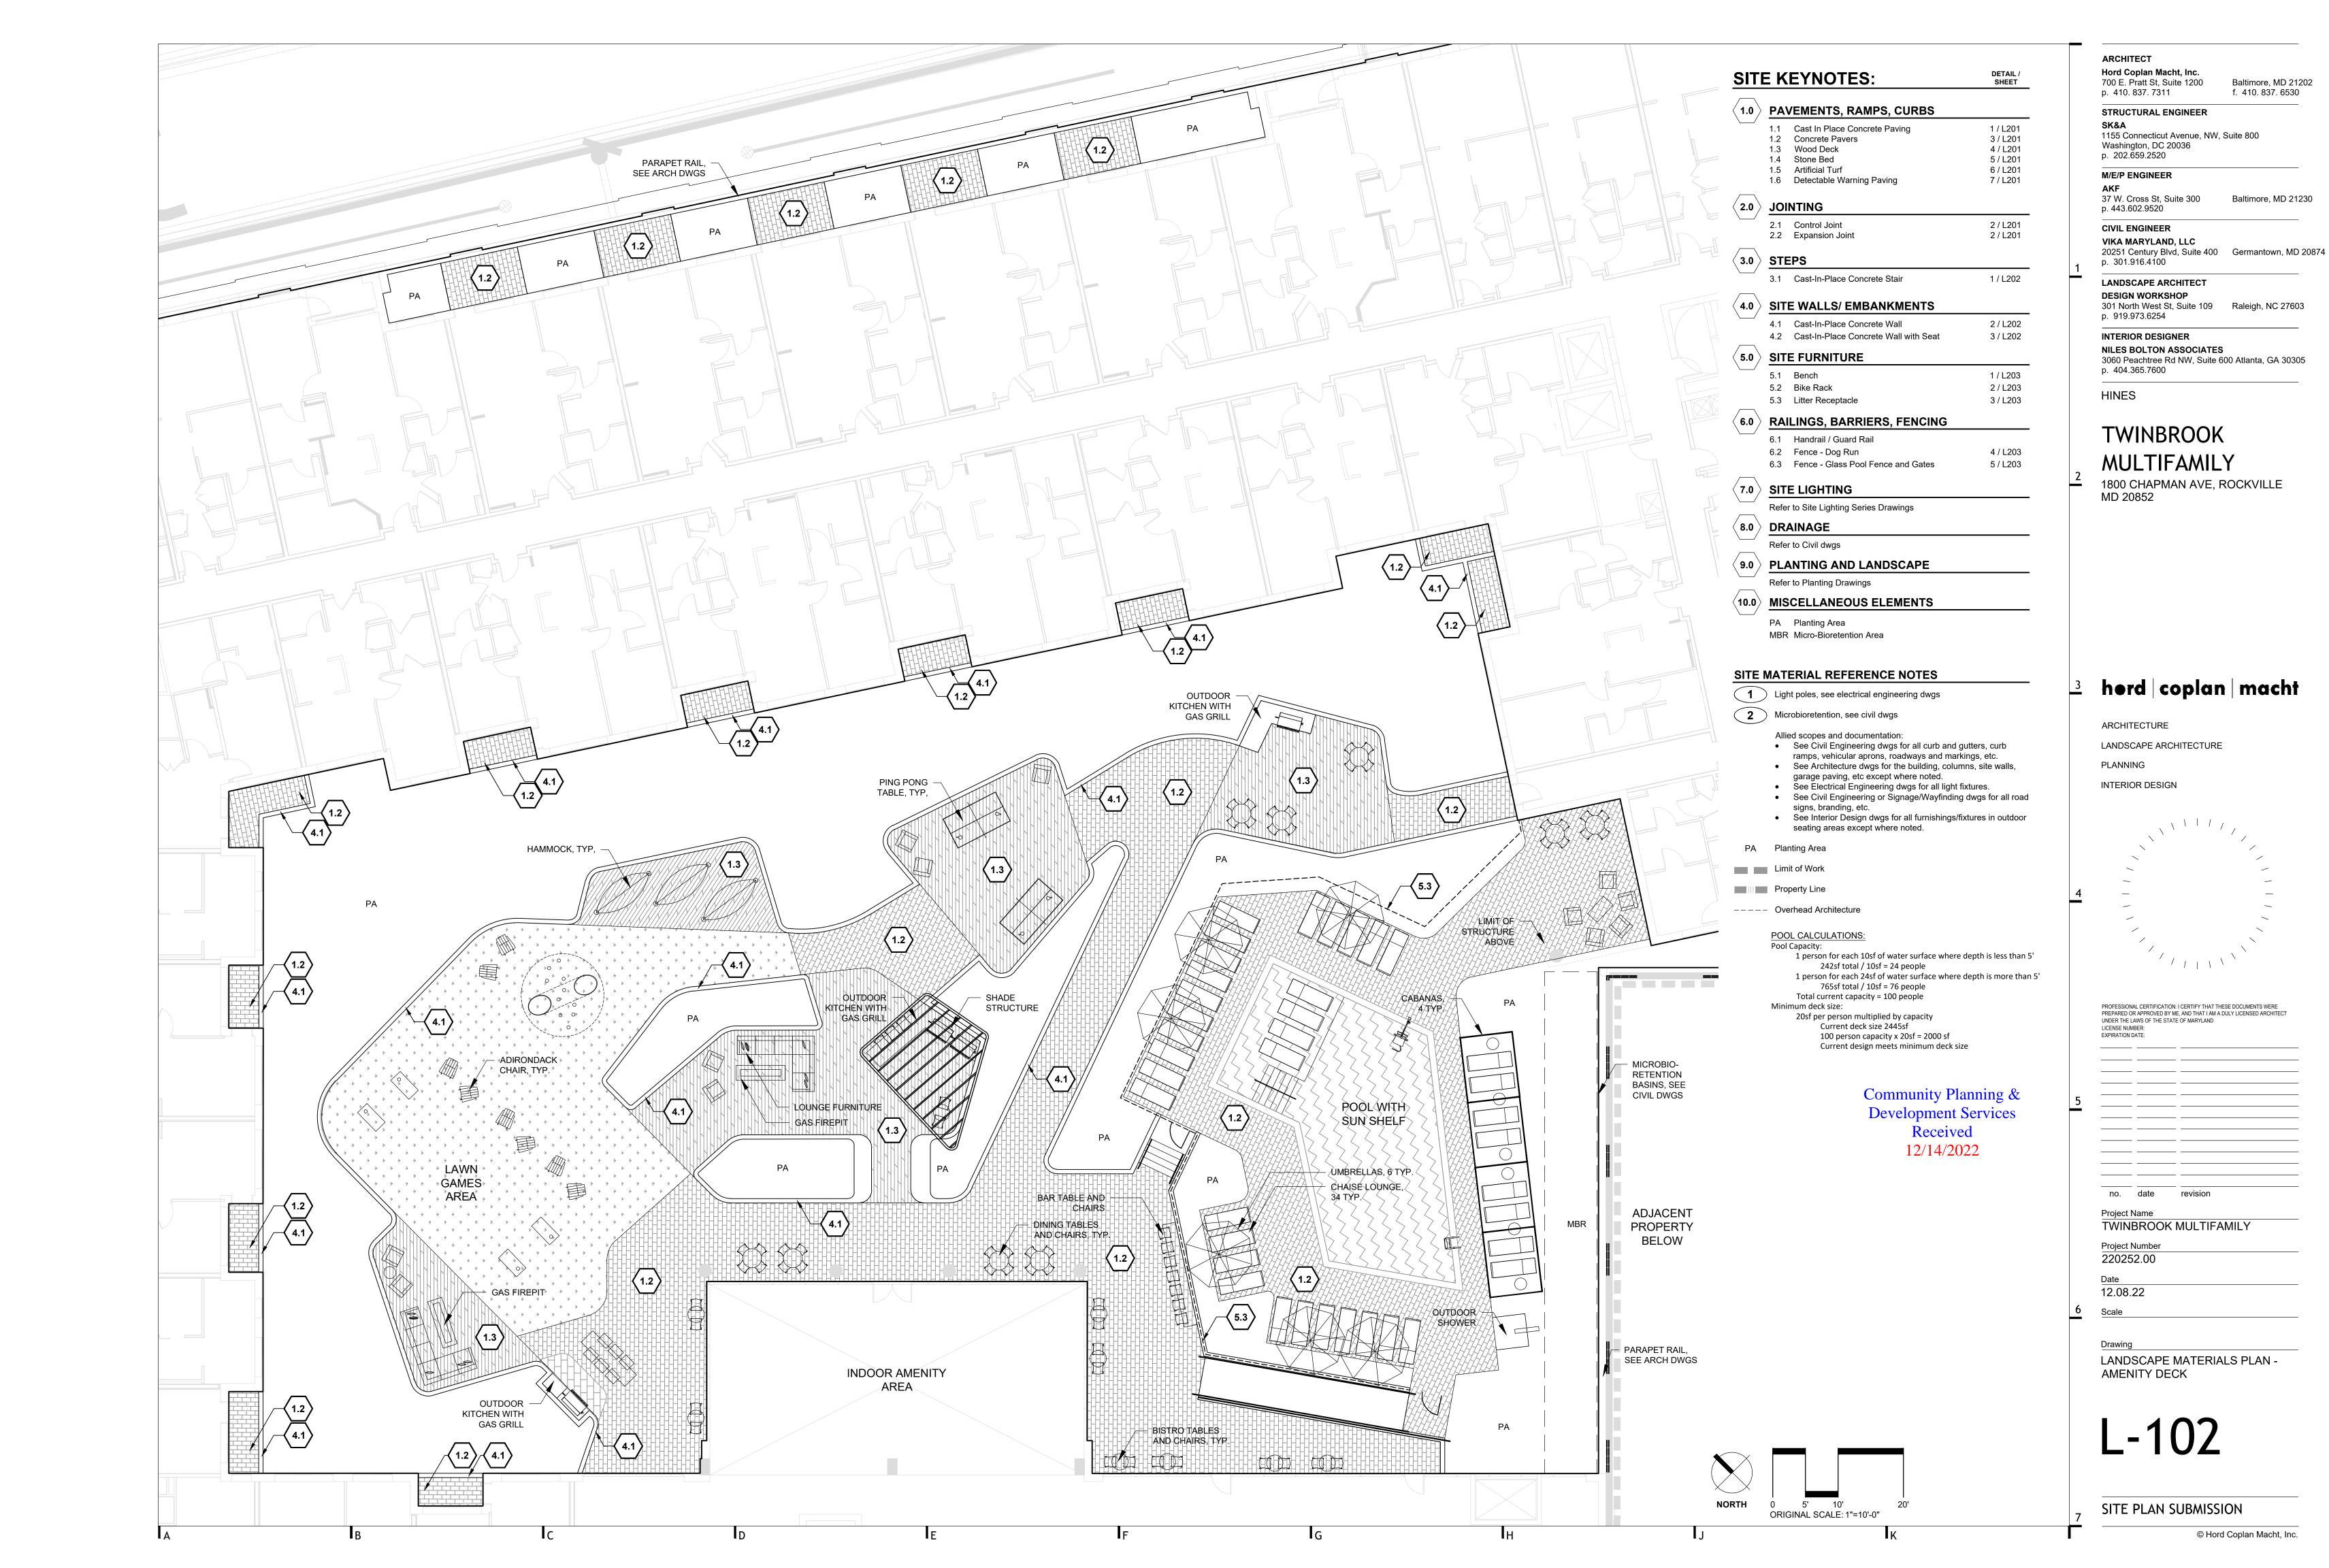
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Washington, DC 20036

37 W. Cross St, Suite 300

VIKA MARYLAND, LLC

LANDSCAPE ARCHITECT

DESIGN WORKSHOP

INTERIOR DESIGNER

NILES BOLTON ASSOCIATES

TWINBROOK

MULTIFAMILY

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3060 Peachtree Rd NW, Suite 600 Atlanta, GA 30305

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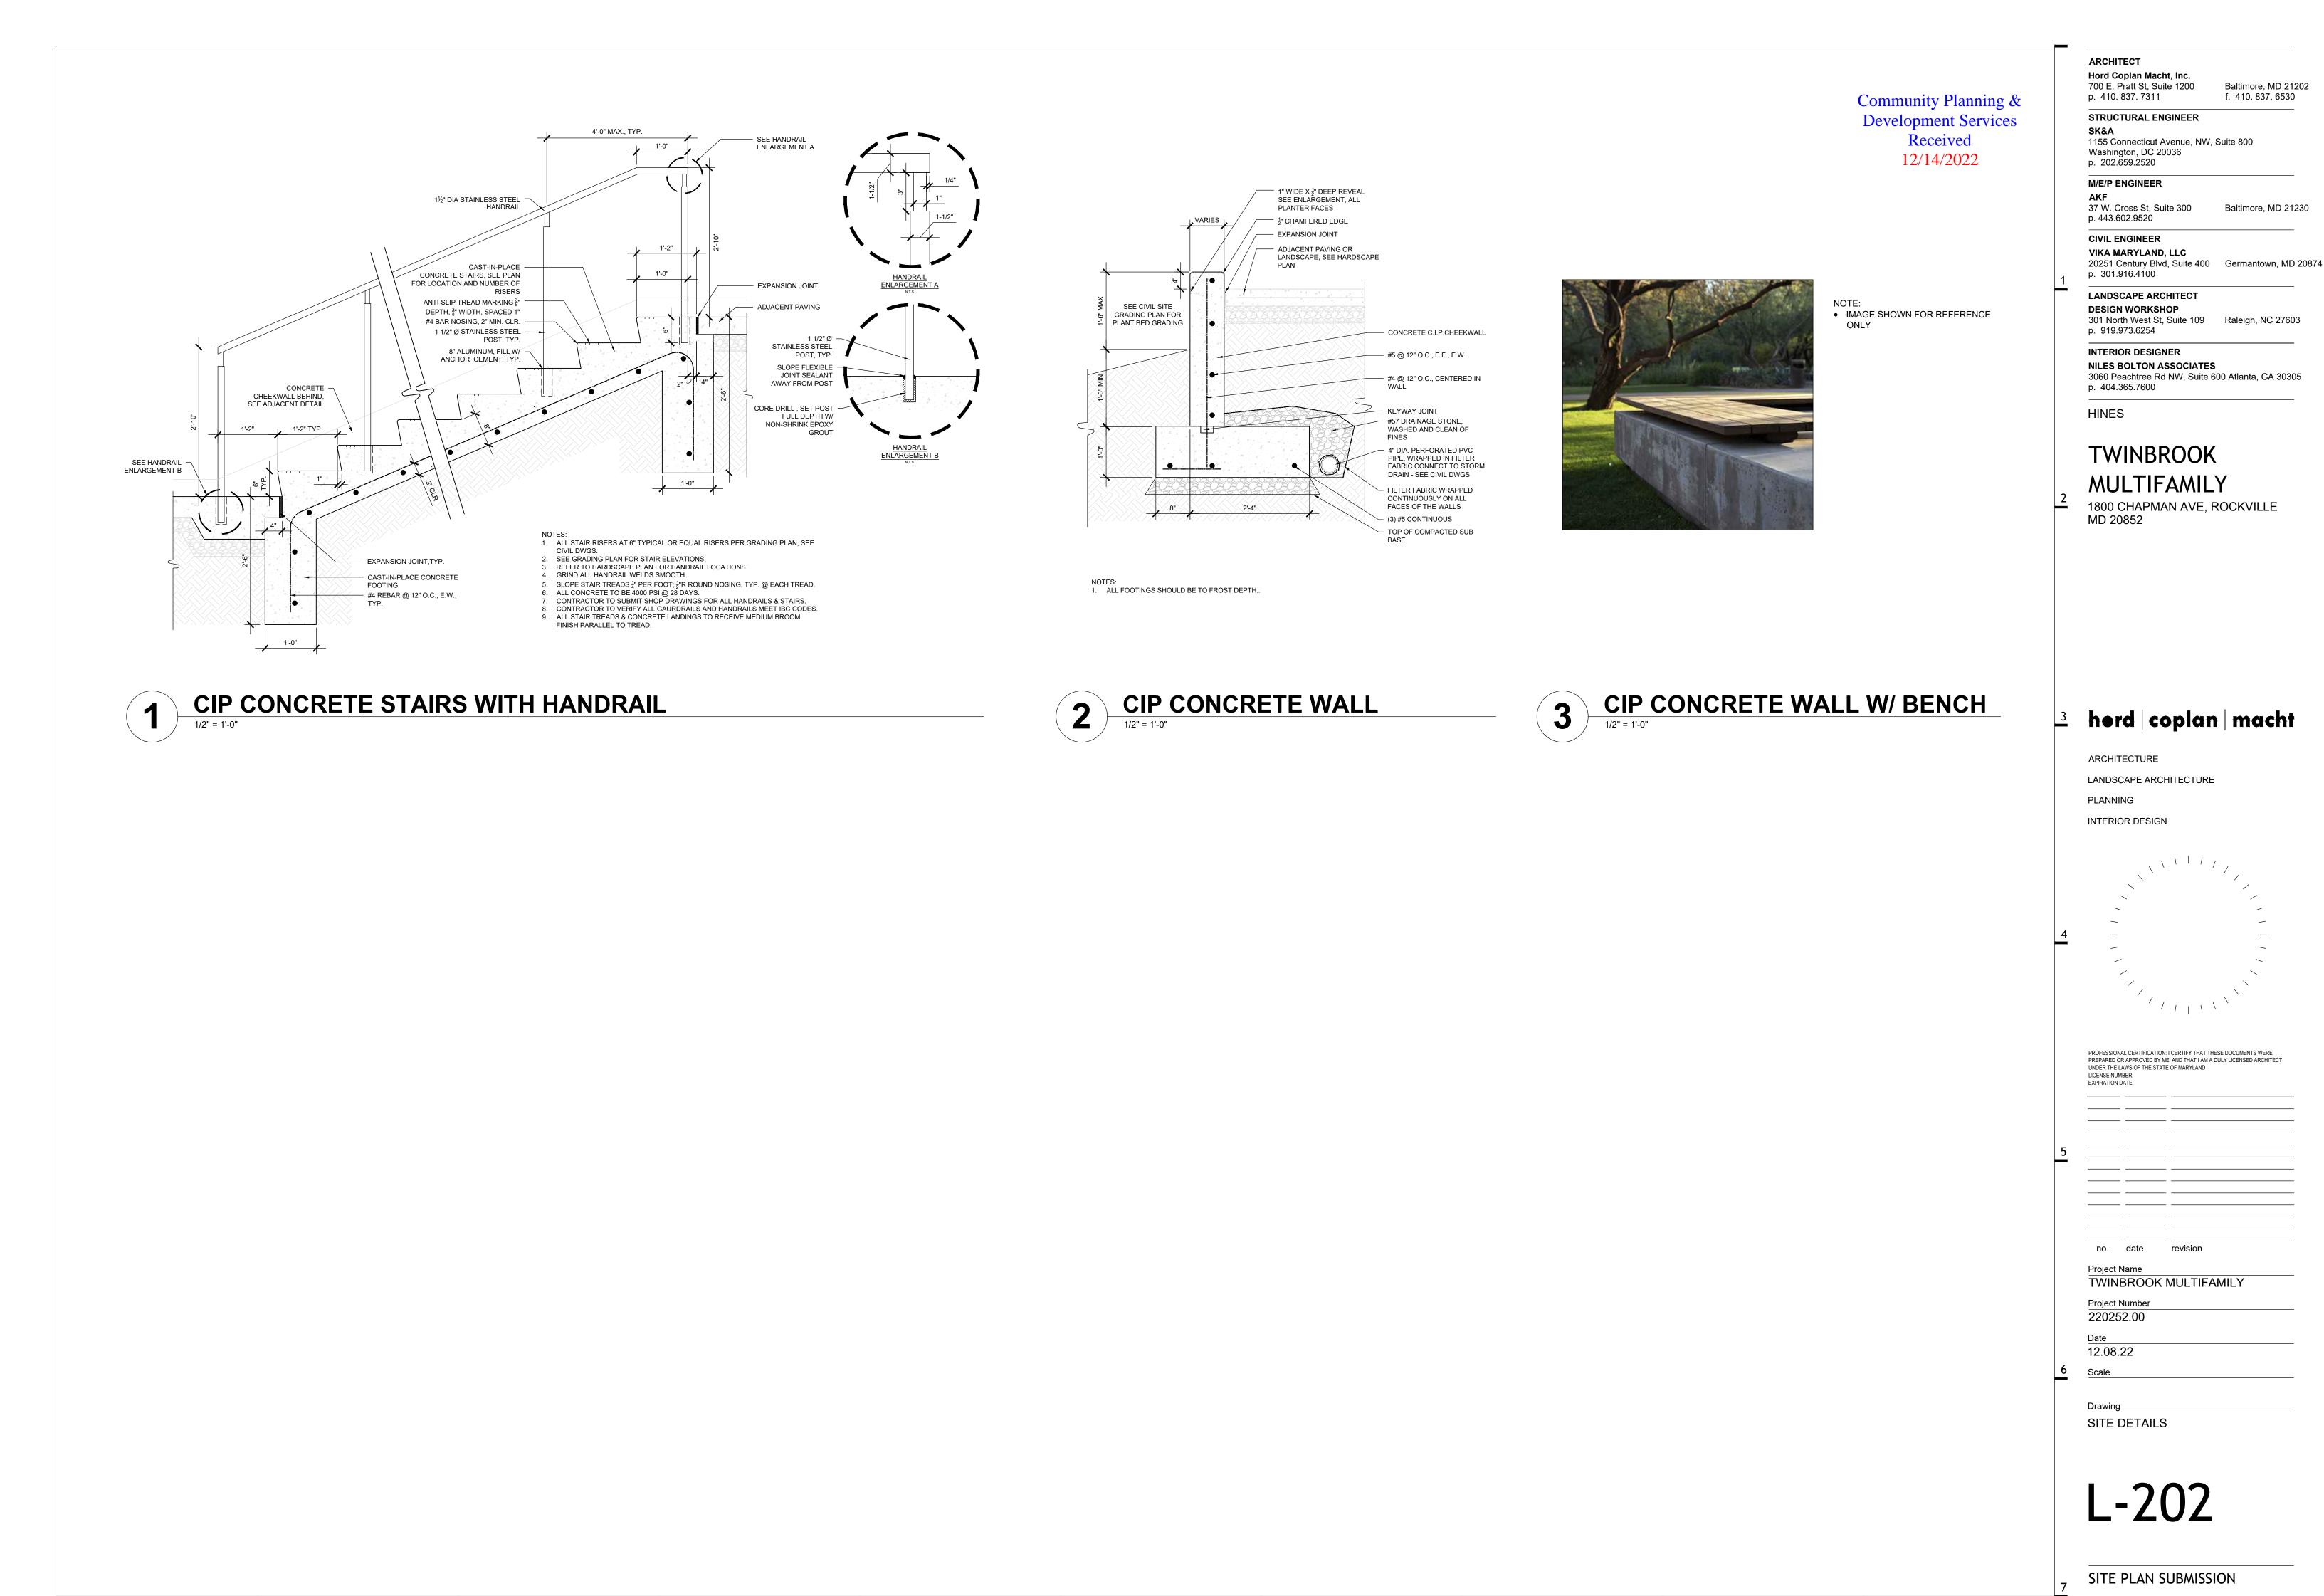
Project Number 220252.00

12.08.22

Drawing SITE DETAILS

SITE PLAN SUBMISSION

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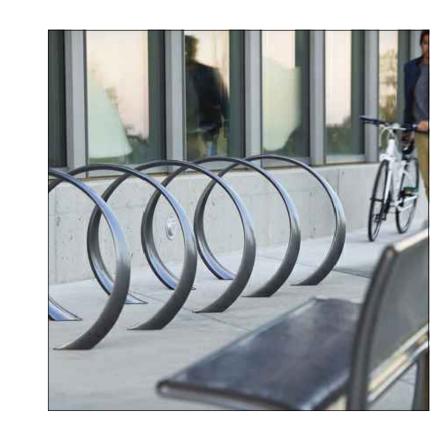
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BENCH, TYP.











BIKE RACK, TYP.

3 LITTER RECEPTACLE, TYP.


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GLASS POOL FENCE



DOG RUN FENCE



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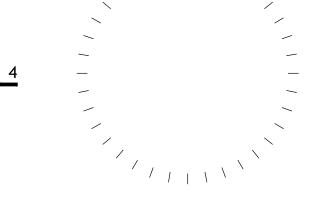
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LANDSCAPE ARCHITECTURE
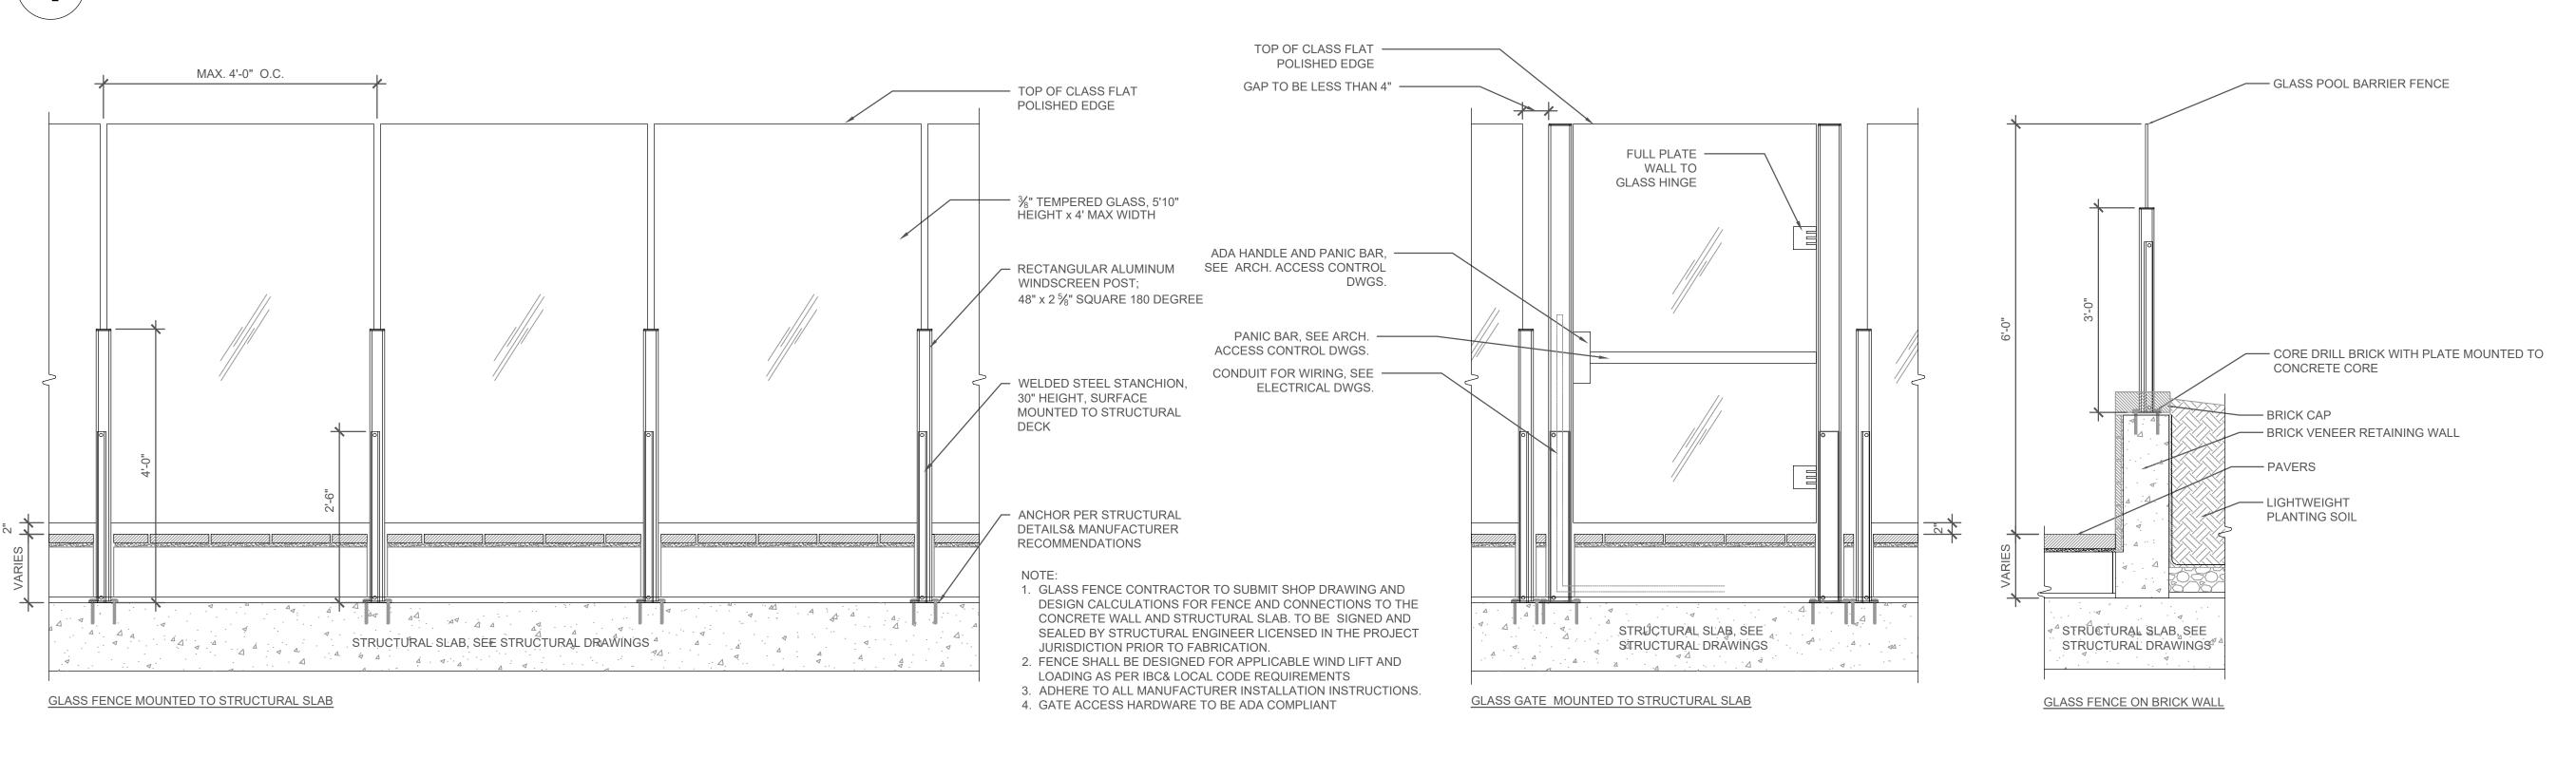
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	UNDER THE LAWS OF THE STATE OF MARYLAND
EXPIRATION DATE:	LICENSE NUMBER:
	EXPIRATION DATE:

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Date 12.08.22 Scale


Drawing
SITE DETAILS

L-203


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Hord Coplan Macht, Inc. 700 E. Pratt St, Suite 1200 Baltimore, MD 21202 f. 410.837.6530 STRUCTURAL ENGINEER 1155 Connecticut Avenue, NW, Suite 800 Washington, DC 20036 37 W. Cross St, Suite 300 Baltimore, MD 21230 VIKA MARYLAND, LLC 20251 Century Blvd, Suite 400 Germantown, MD 20874 LANDSCAPE ARCHITECT **DESIGN WORKSHOP** 301 North West St, Suite 109 Raleigh, NC 27603 INTERIOR DESIGNER **NILES BOLTON ASSOCIATES** 3060 Peachtree Rd NW, Suite 600 Atlanta, GA 30305

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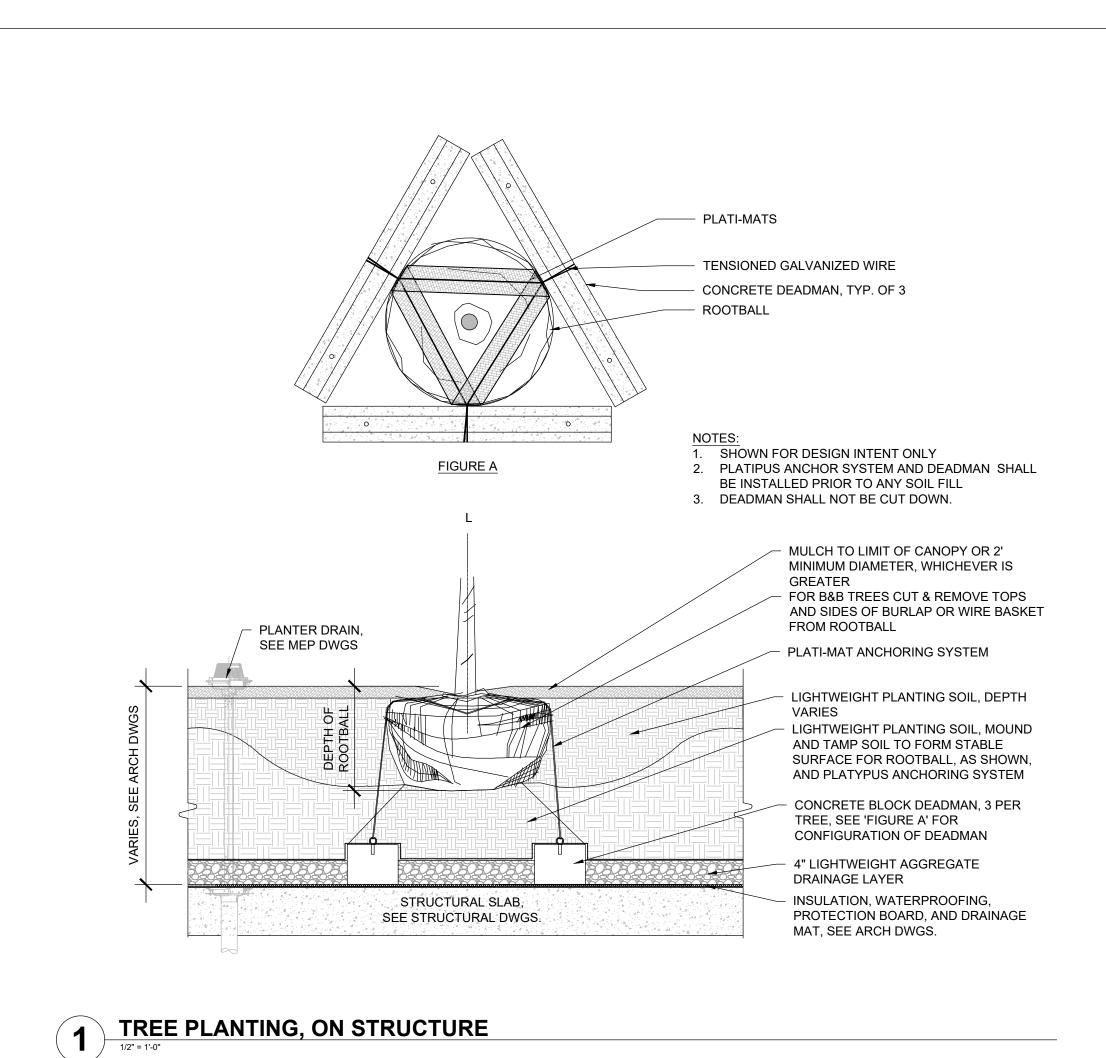
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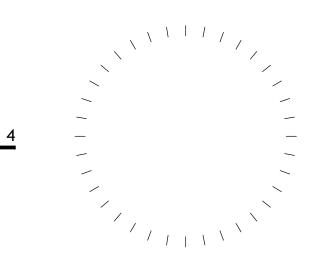
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TWINBROOK MULTIFAMILY

Project Number 220252.00

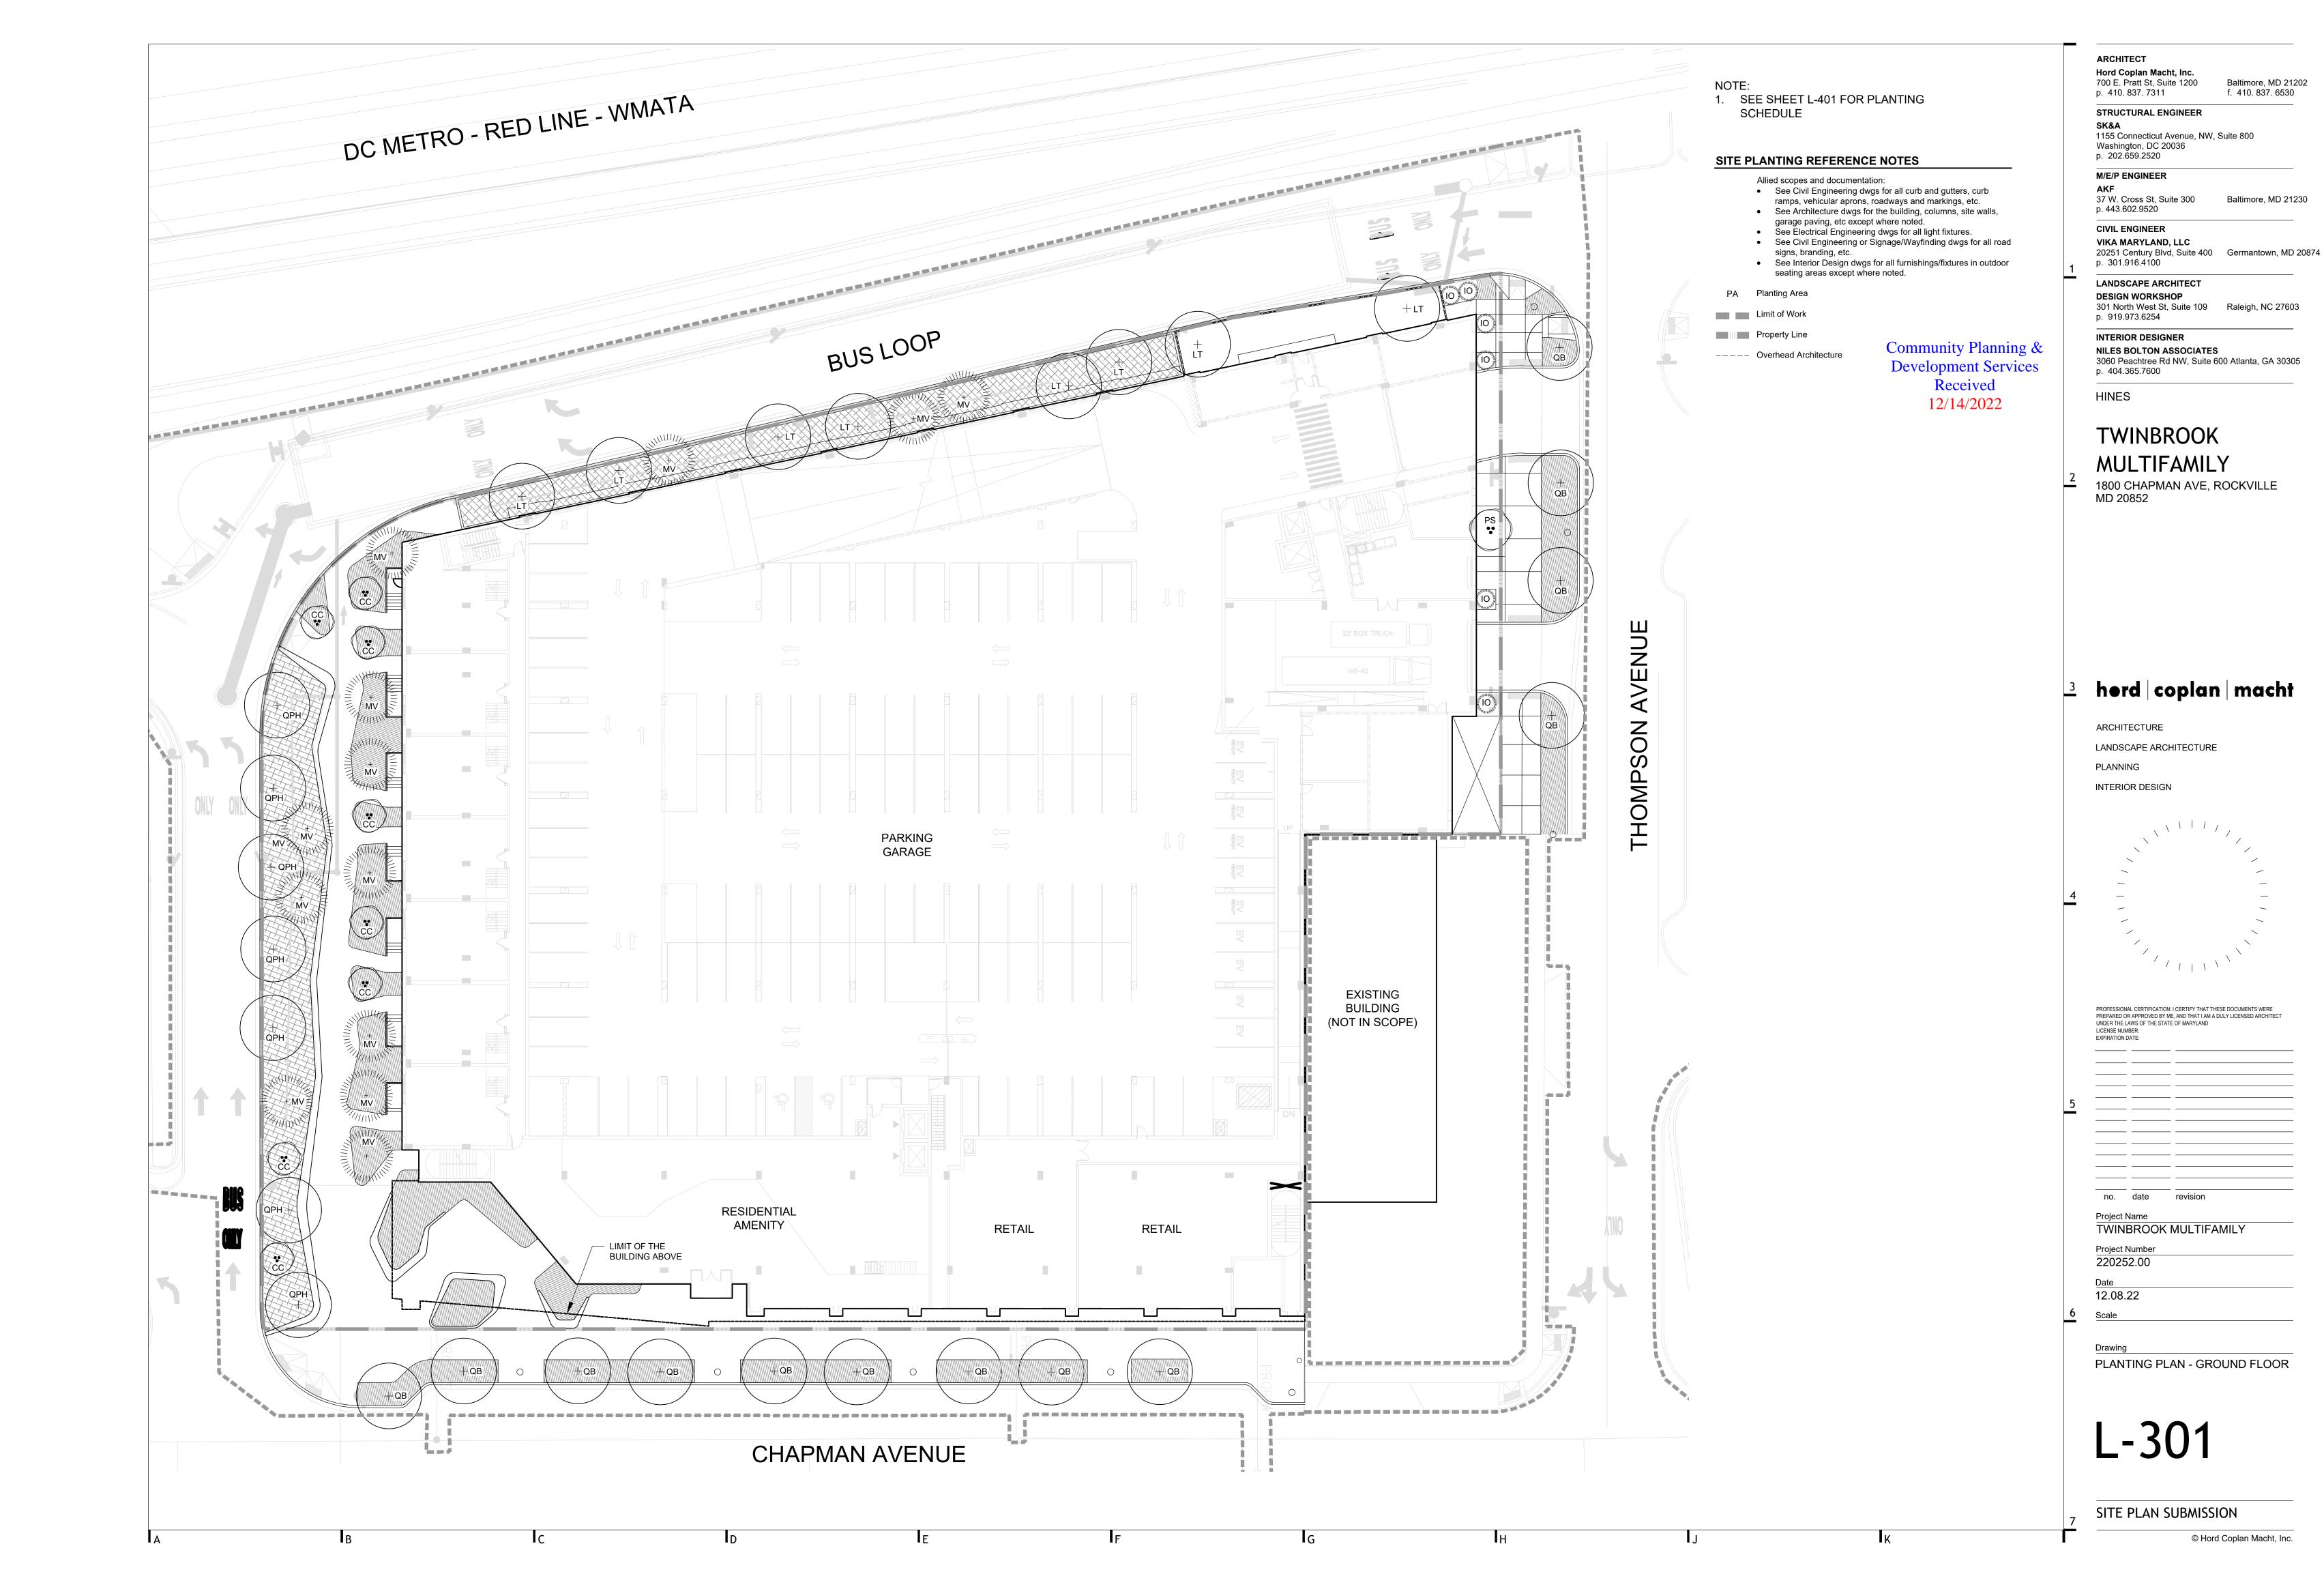Date 12.08.22


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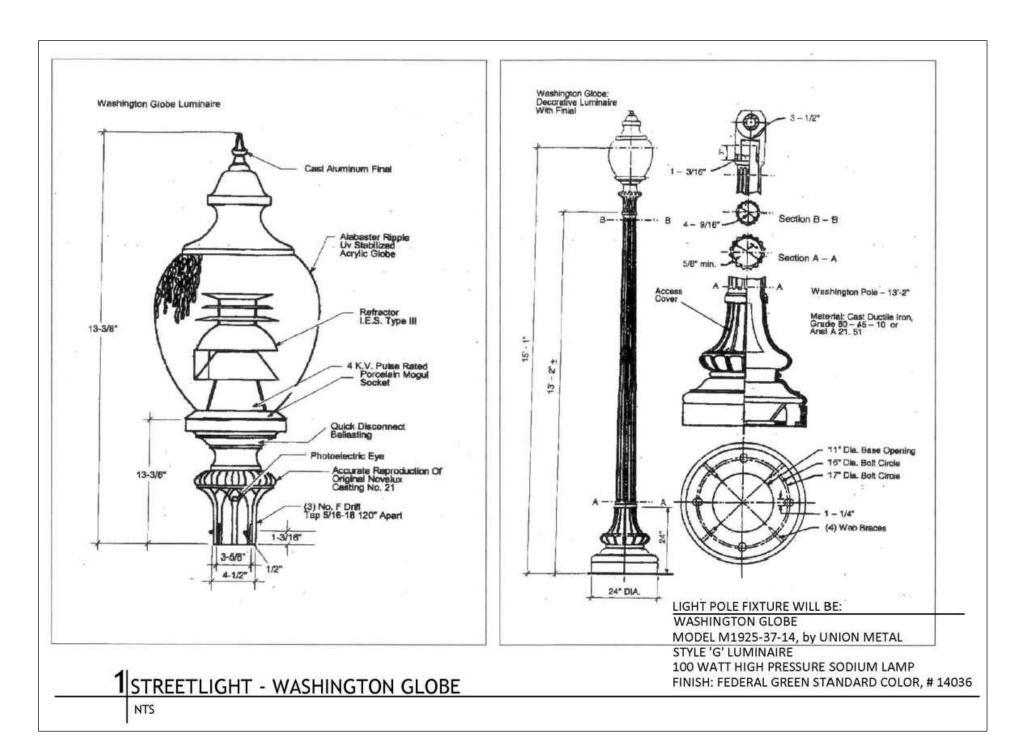
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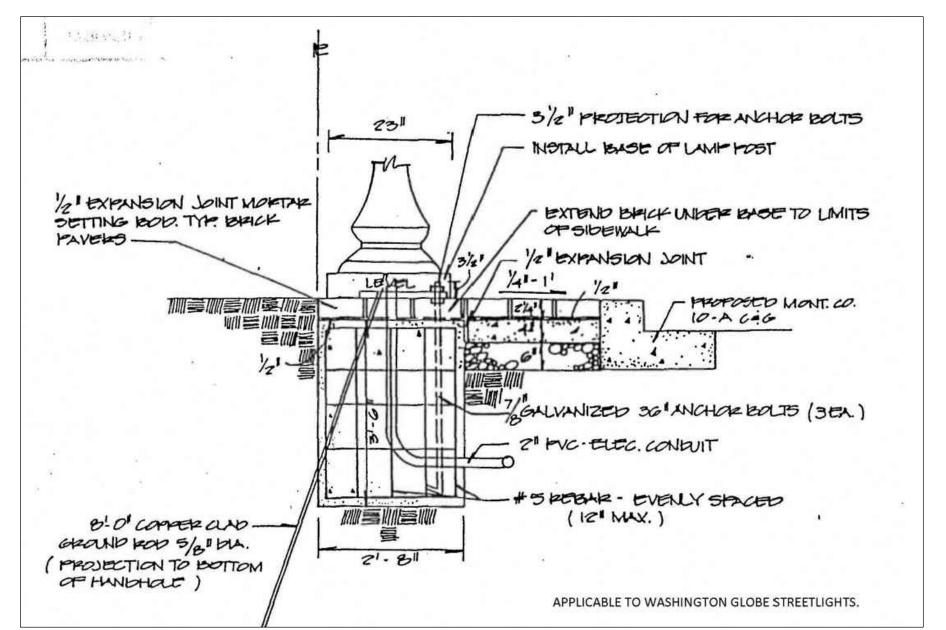
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, SITE PLAN SUBMISSION
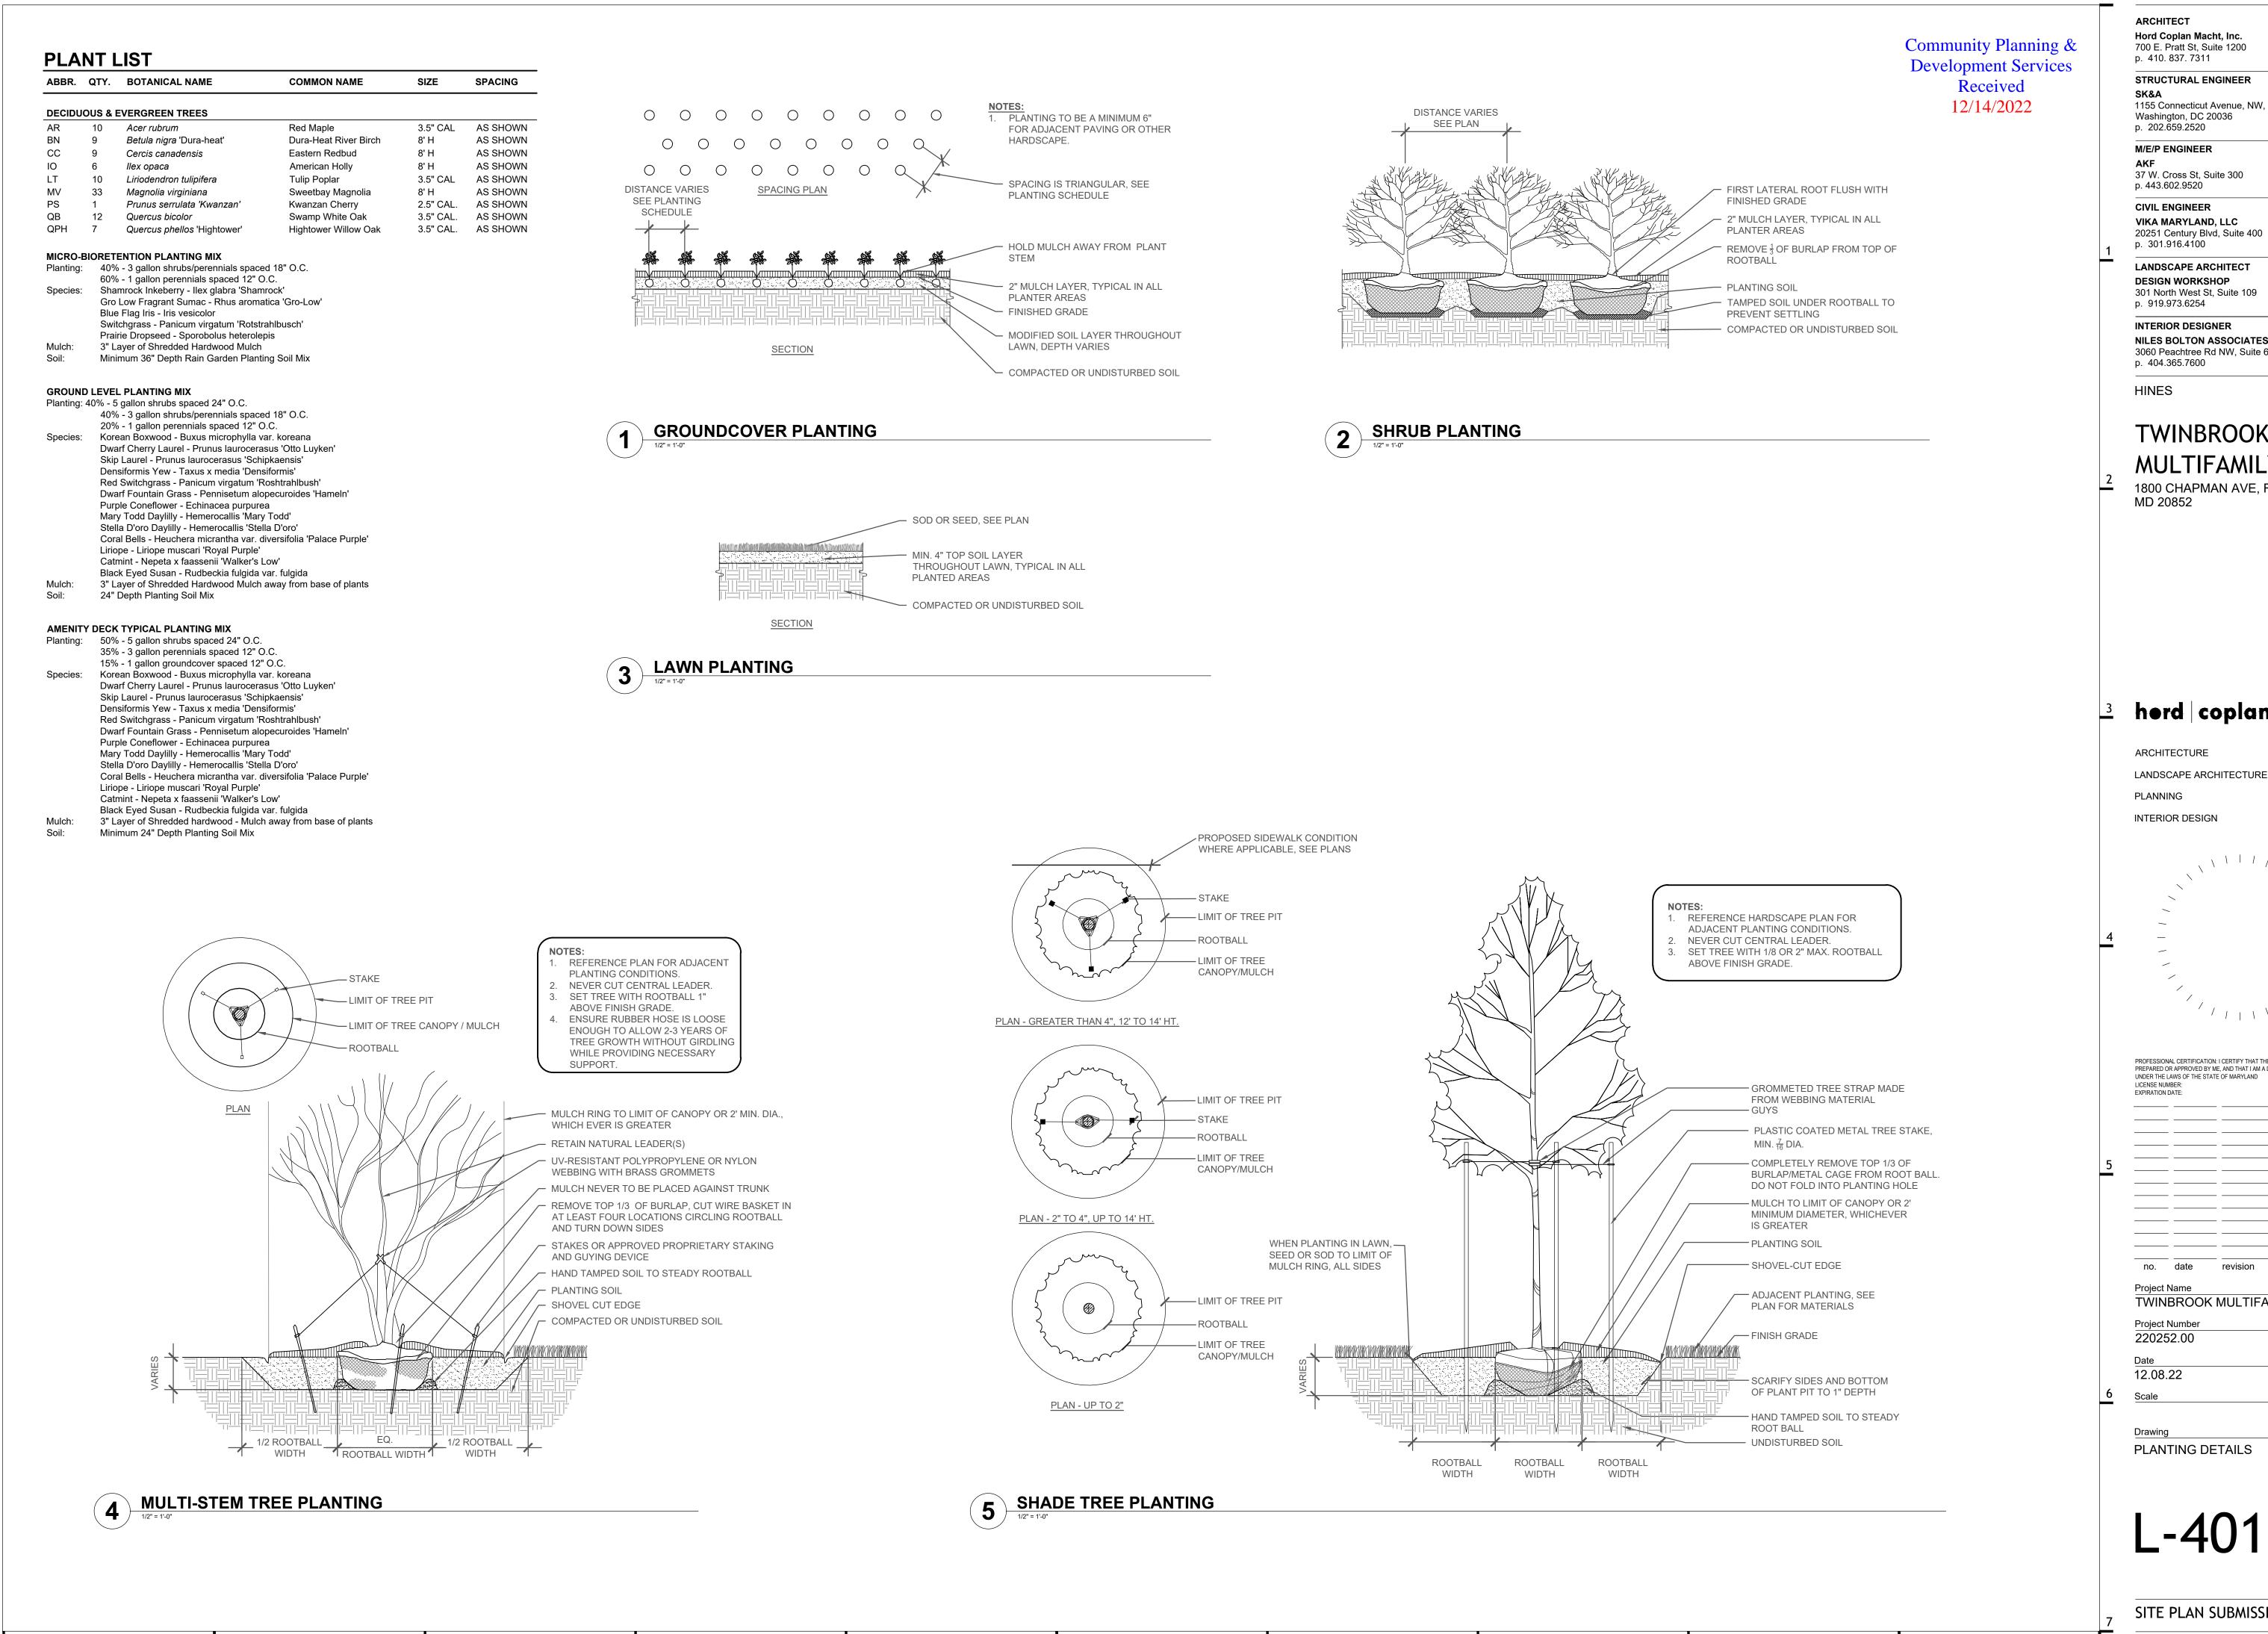
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1 STREETLIGHT, TYPICAL N.T.S.

2 STREETLIGHT FOUNDATION, TYPICAL N.T.S.



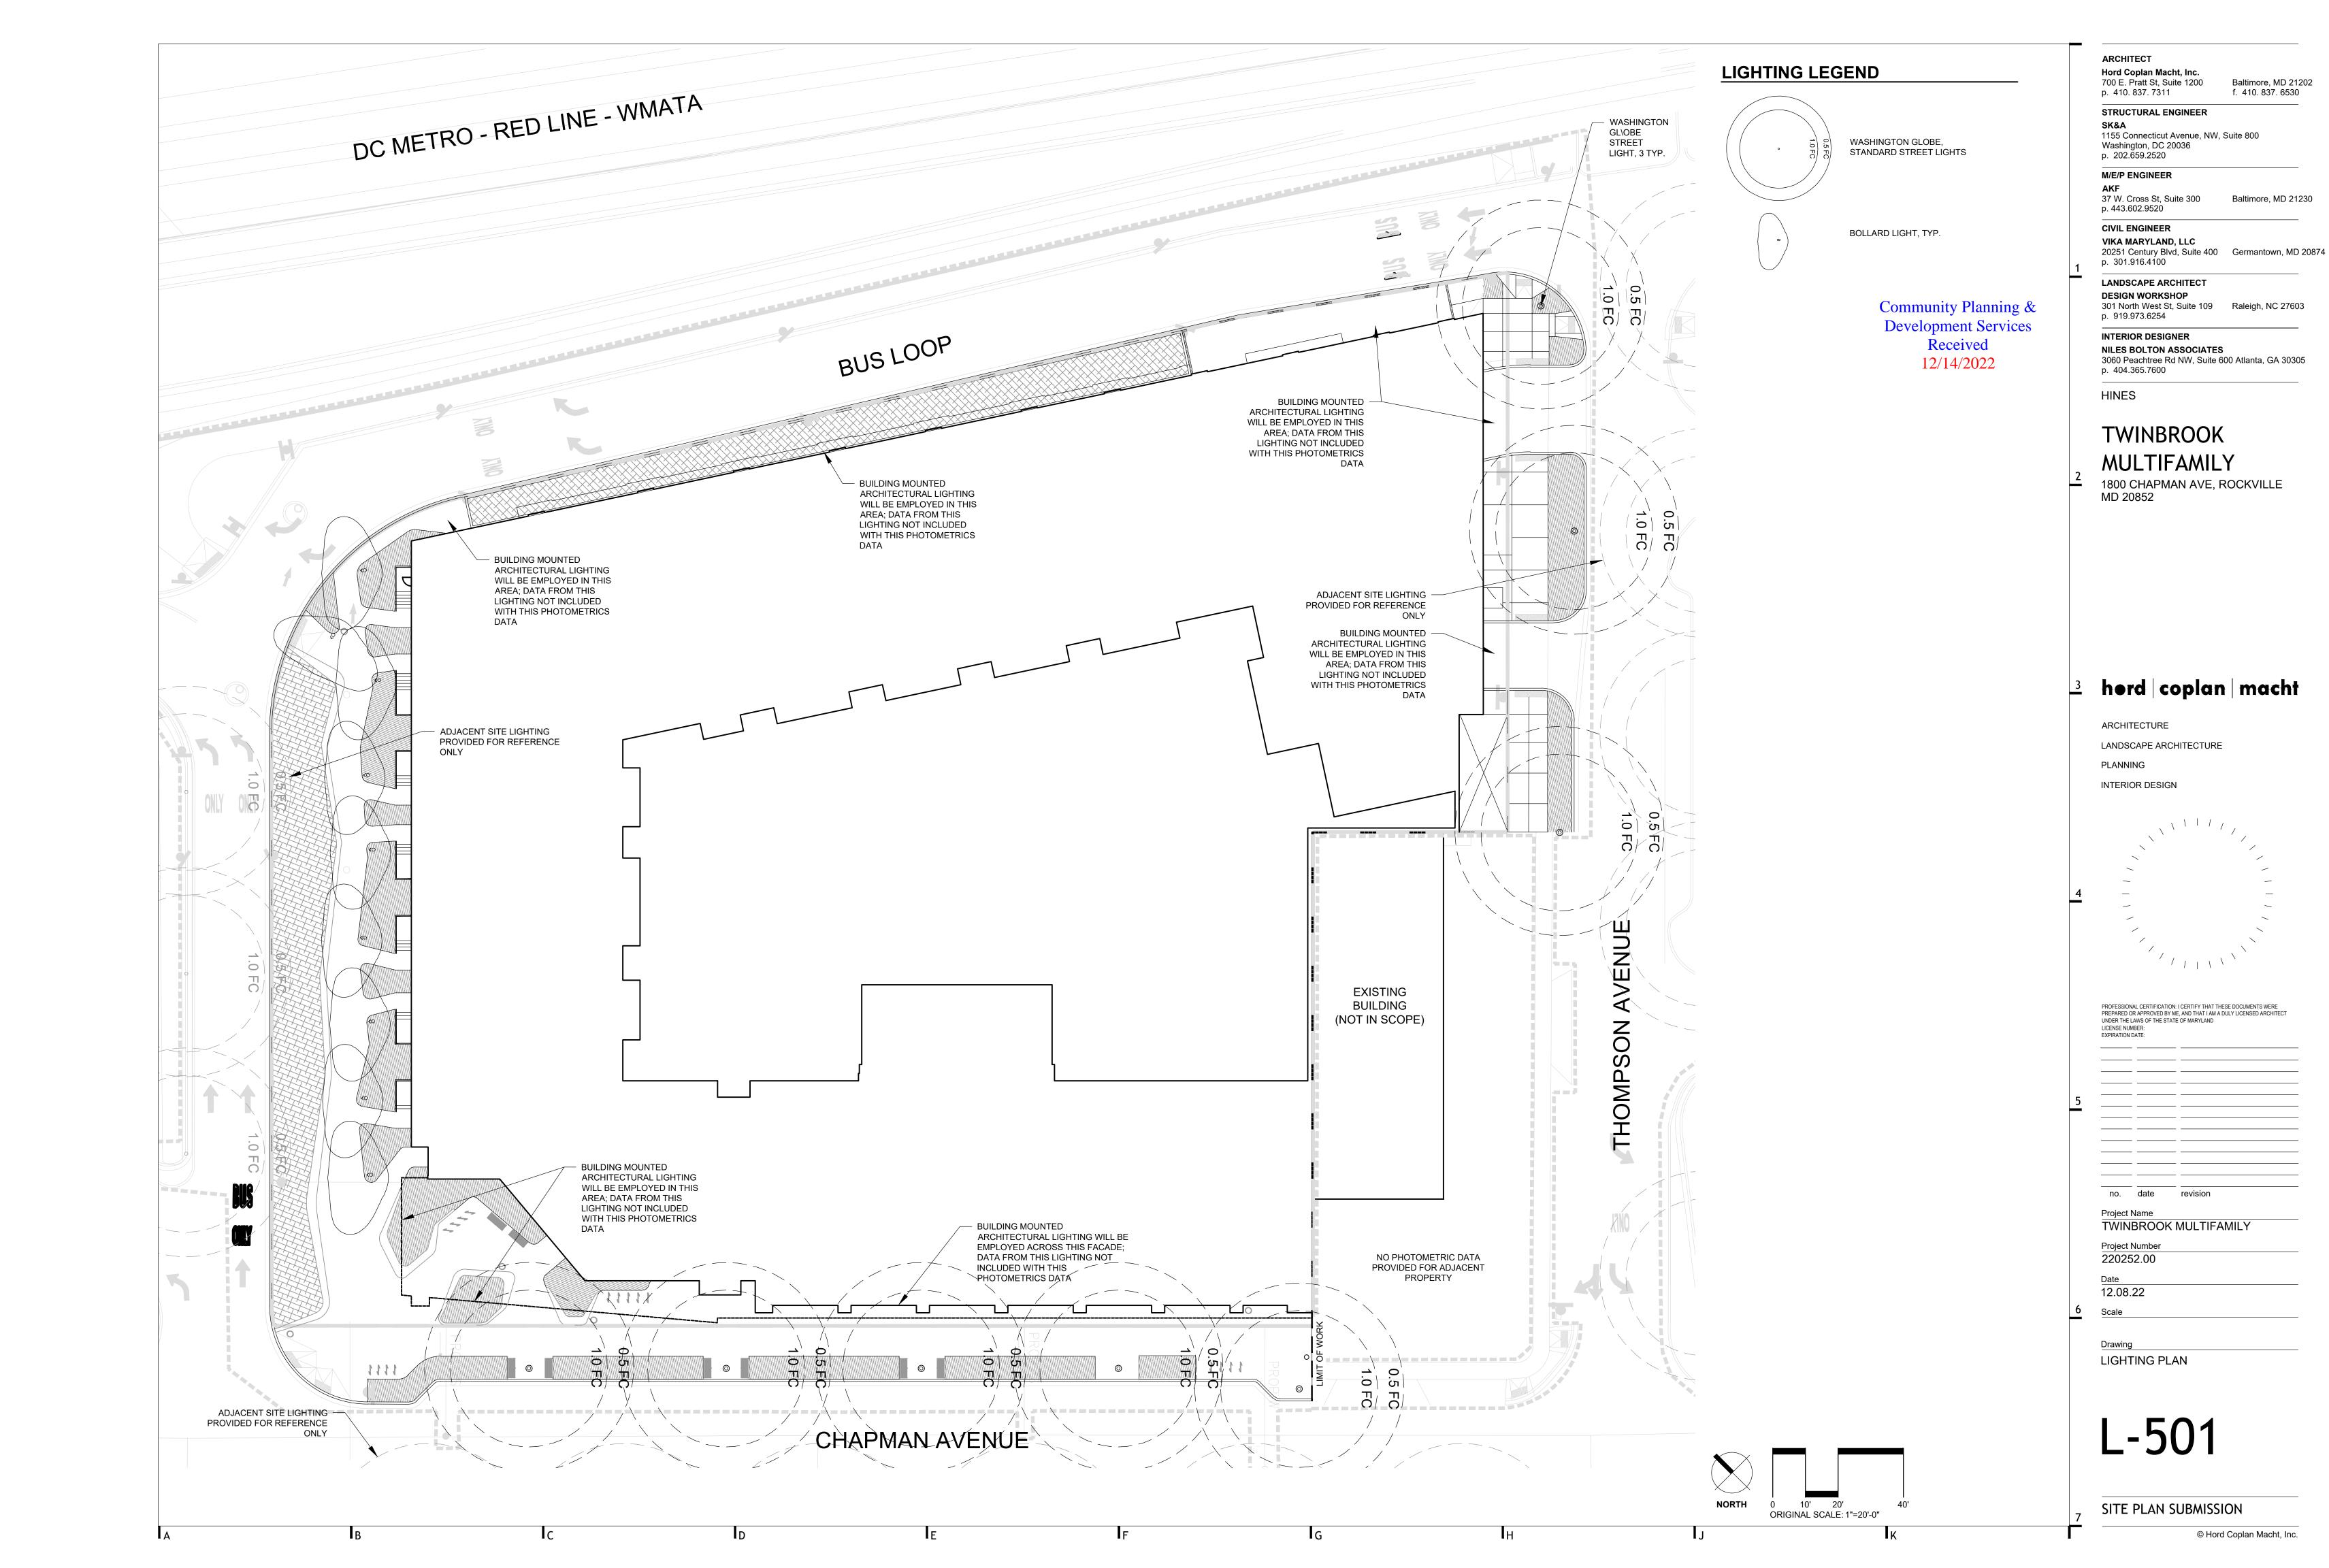

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BOLLARD LIGHT, TYPICAL

N.T.S.

1155 Connecticut Avenue, NW, Suite 800 Washington, DC 20036 p. 202.659.2520 M/E/P ENGINEER 37 W. Cross St, Suite 300 Baltimore, MD 21230 p. 443.602.9520 **CIVIL ENGINEER** VIKA MARYLAND, LLC 20251 Century Blvd, Suite 400 Germantown, MD 20874 p. 301.916.4100 LANDSCAPE ARCHITECT **DESIGN WORKSHOP** 301 North West St, Suite 109 Raleigh, NC 27603 p. 919.973.6254 INTERIOR DESIGNER NILES BOLTON ASSOCIATES 3060 Peachtree Rd NW, Suite 600 Atlanta, GA 30305 p. 404.365.7600 HINES **TWINBROOK MULTIFAMILY** 1800 CHAPMAN AVE, ROCKVILLE MD 20852 herd coplan macht ARCHITECTURE LANDSCAPE ARCHITECTURE PLANNING INTERIOR DESIGN PROFESSIONAL CERTIFICATION: I CERTIFY THAT THESE DOCUMENTS WERE PREPARED OR APPROVED BY ME, AND THAT I AM A DULY LICENSED ARCHITECT UNDER THE LAWS OF THE STATE OF MARYLAND LICENSE NUMBER: EXPIRATION DATE: no. date revision Project Name TWINBROOK MULTIFAMILY Project Number 220252.00 12.08.22 LIGHTING DETAILS L-601

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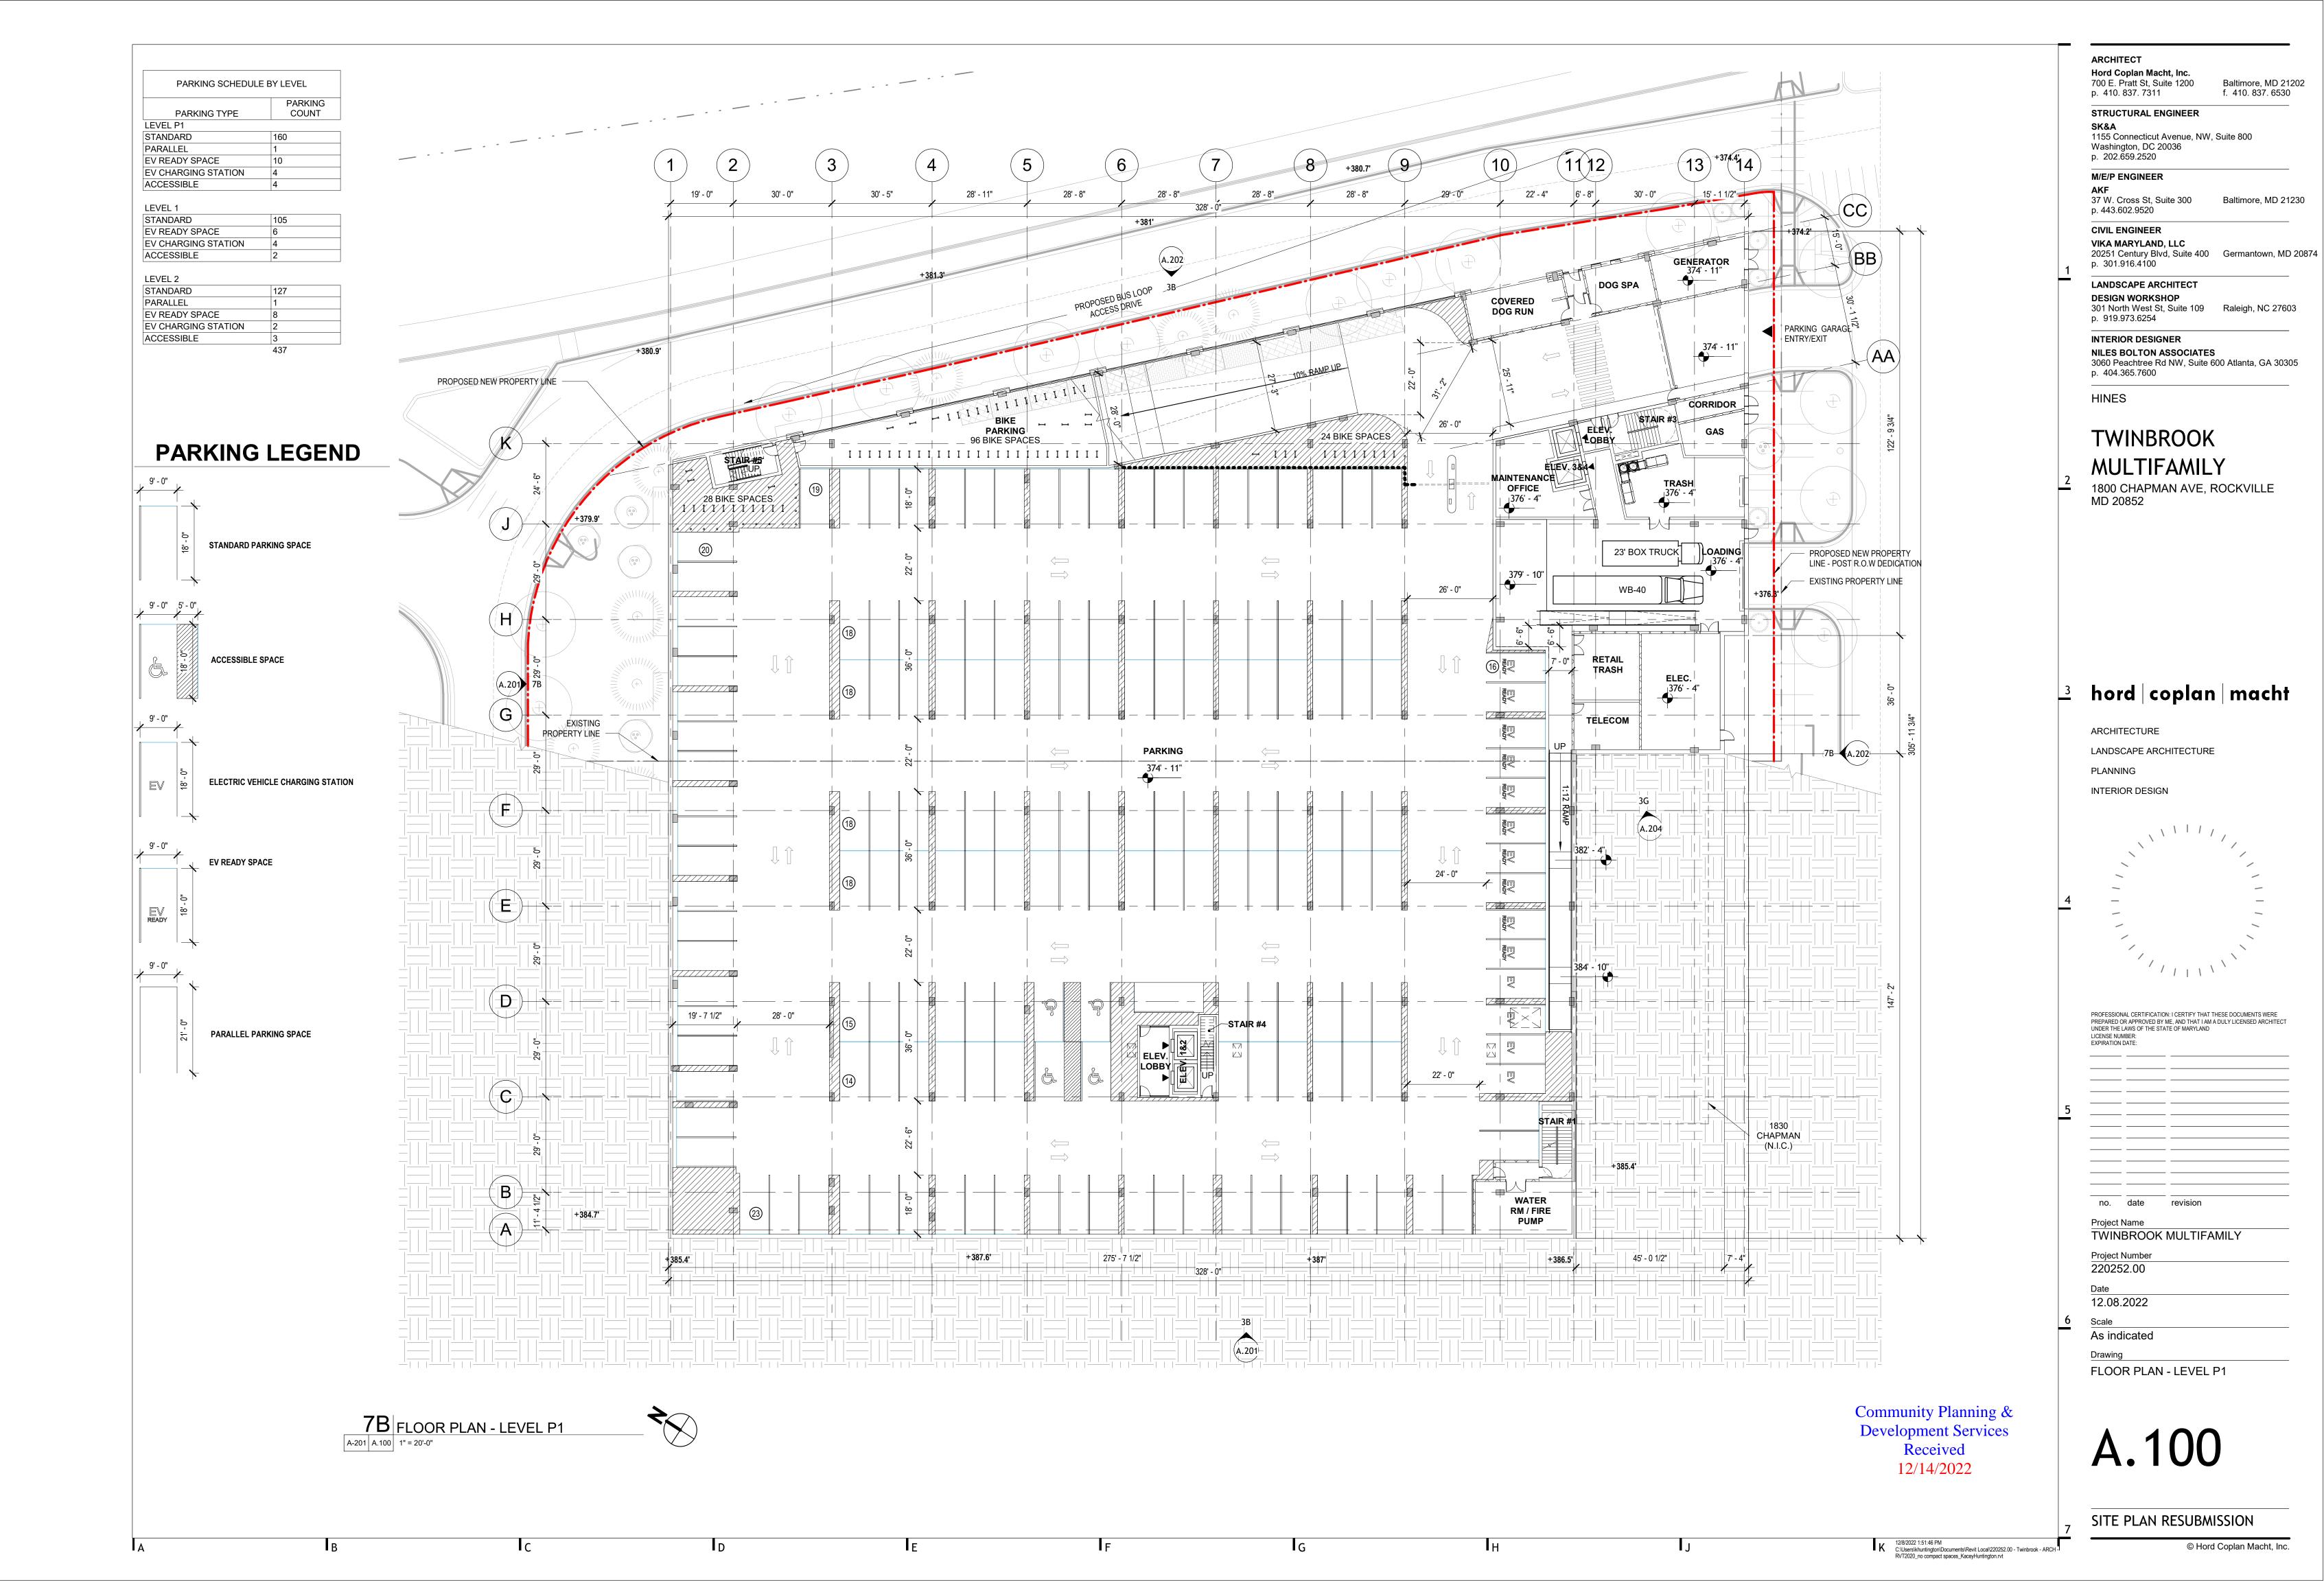
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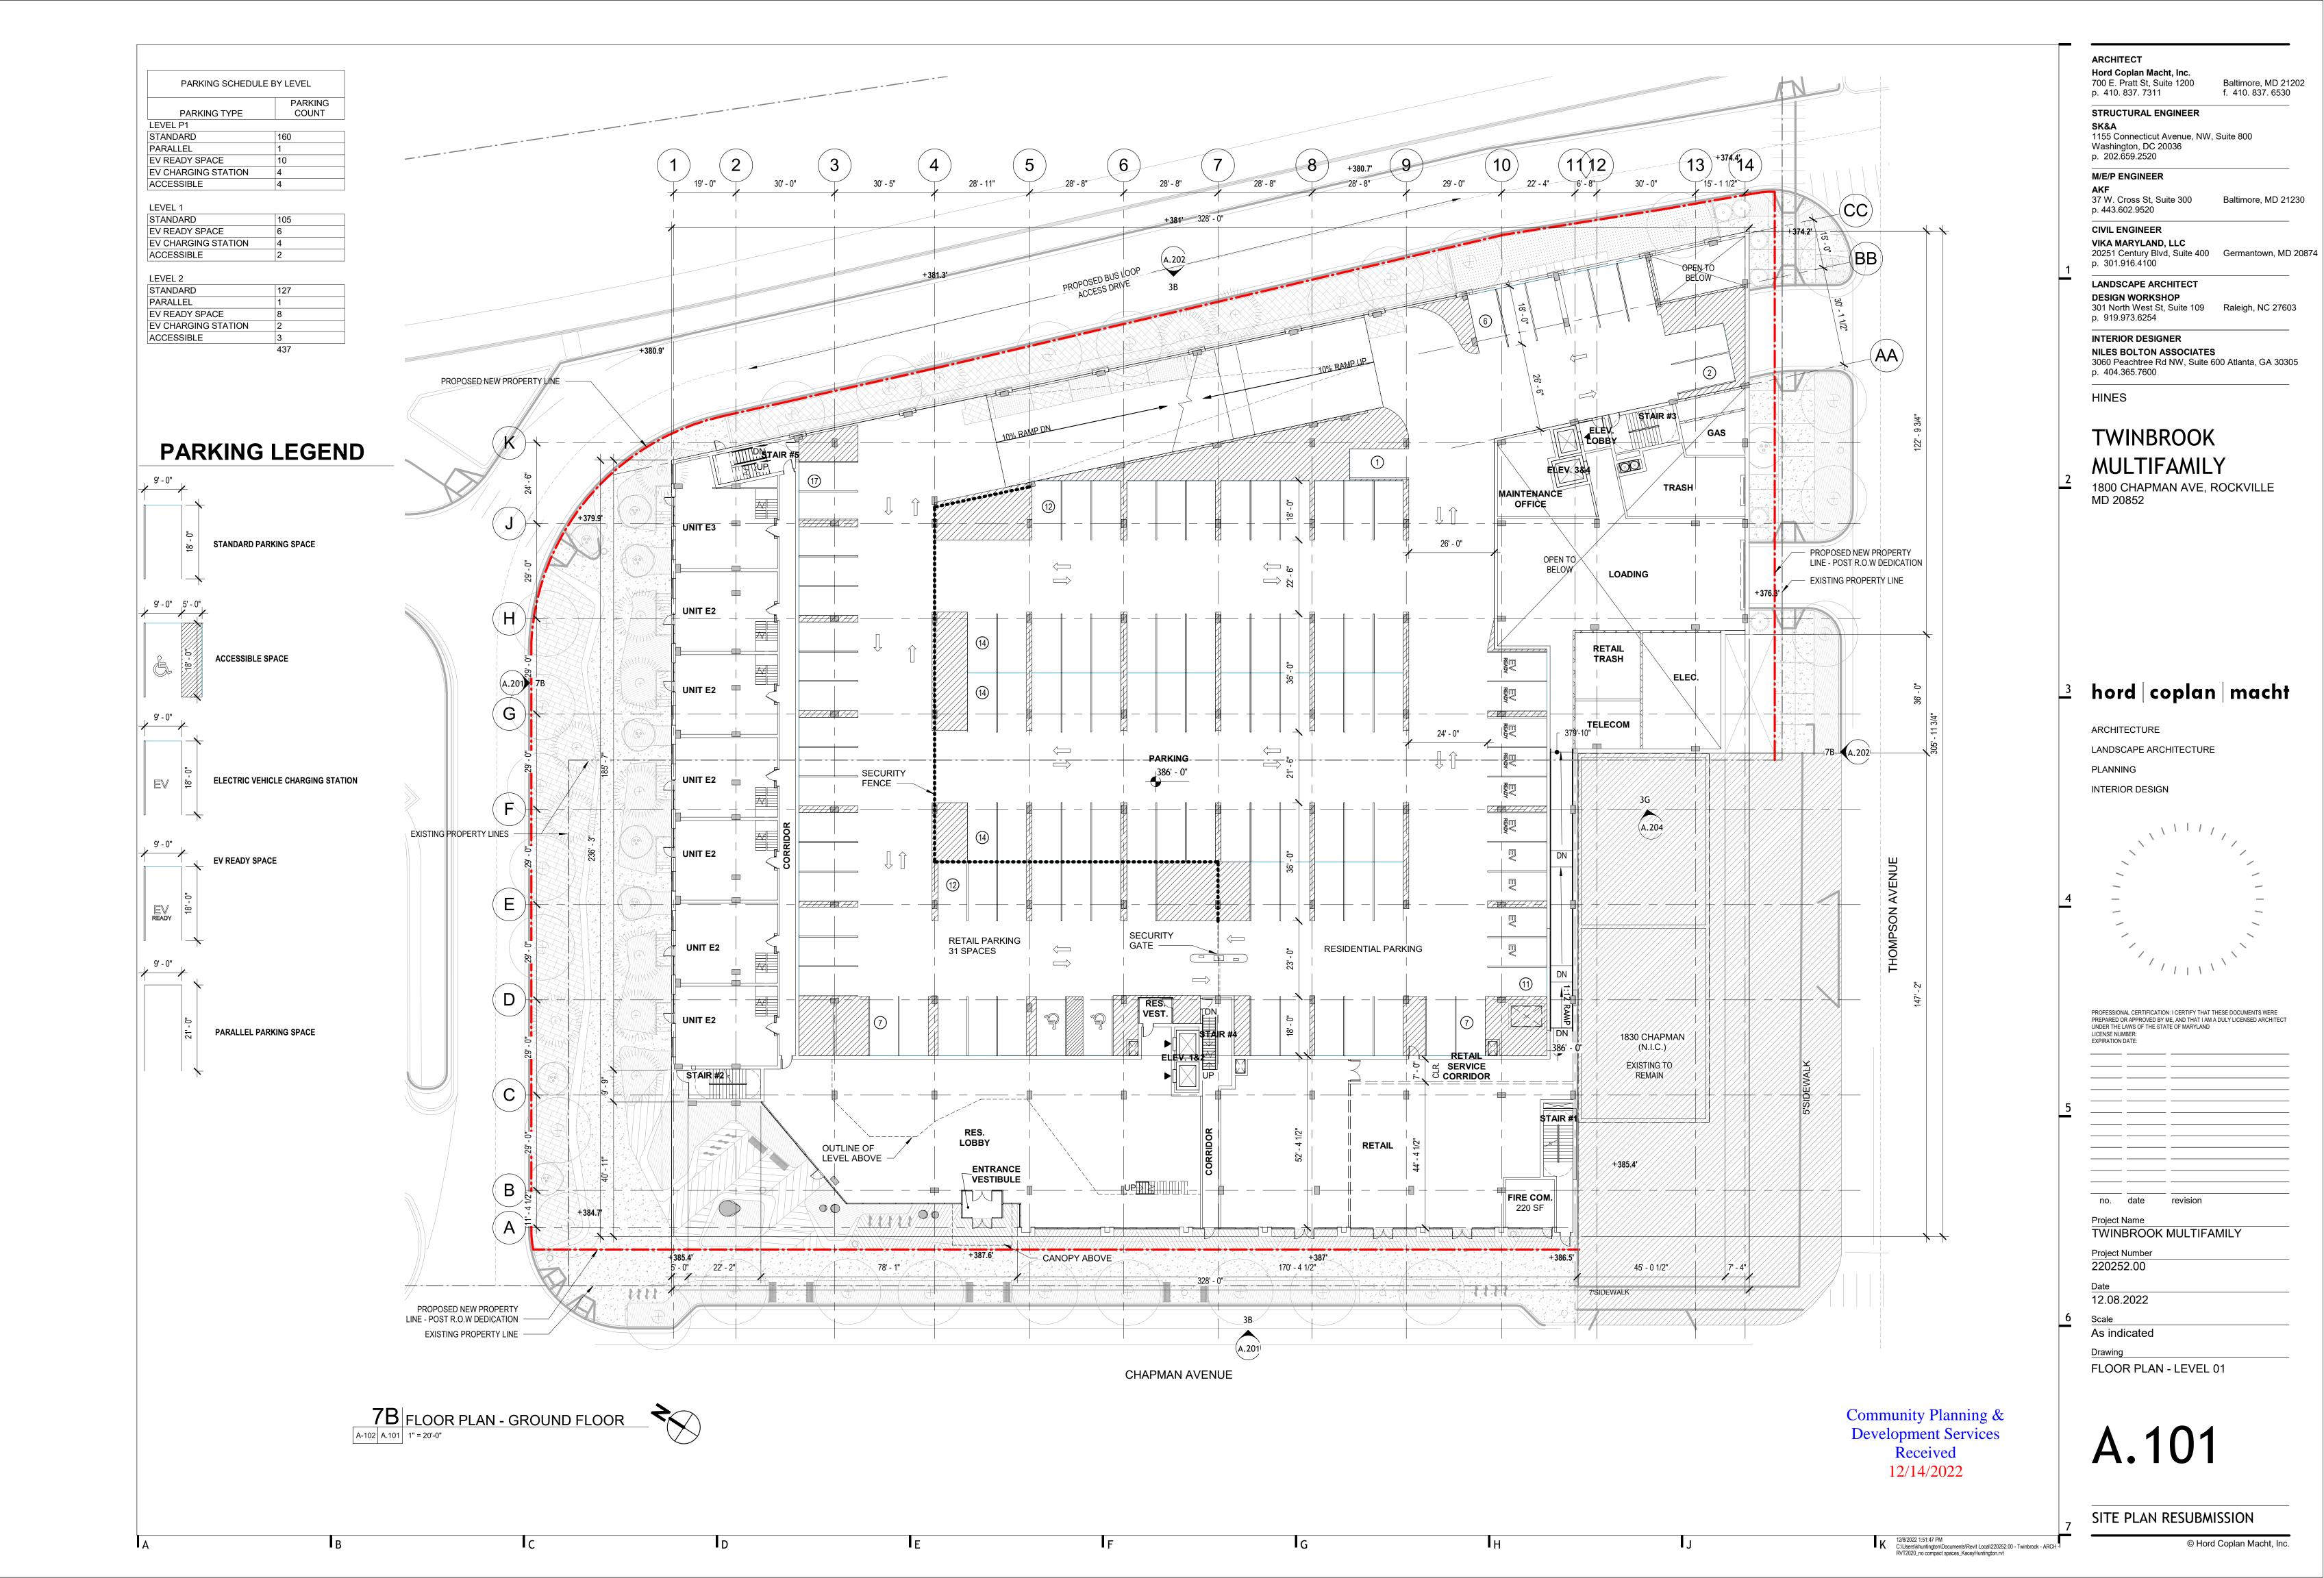
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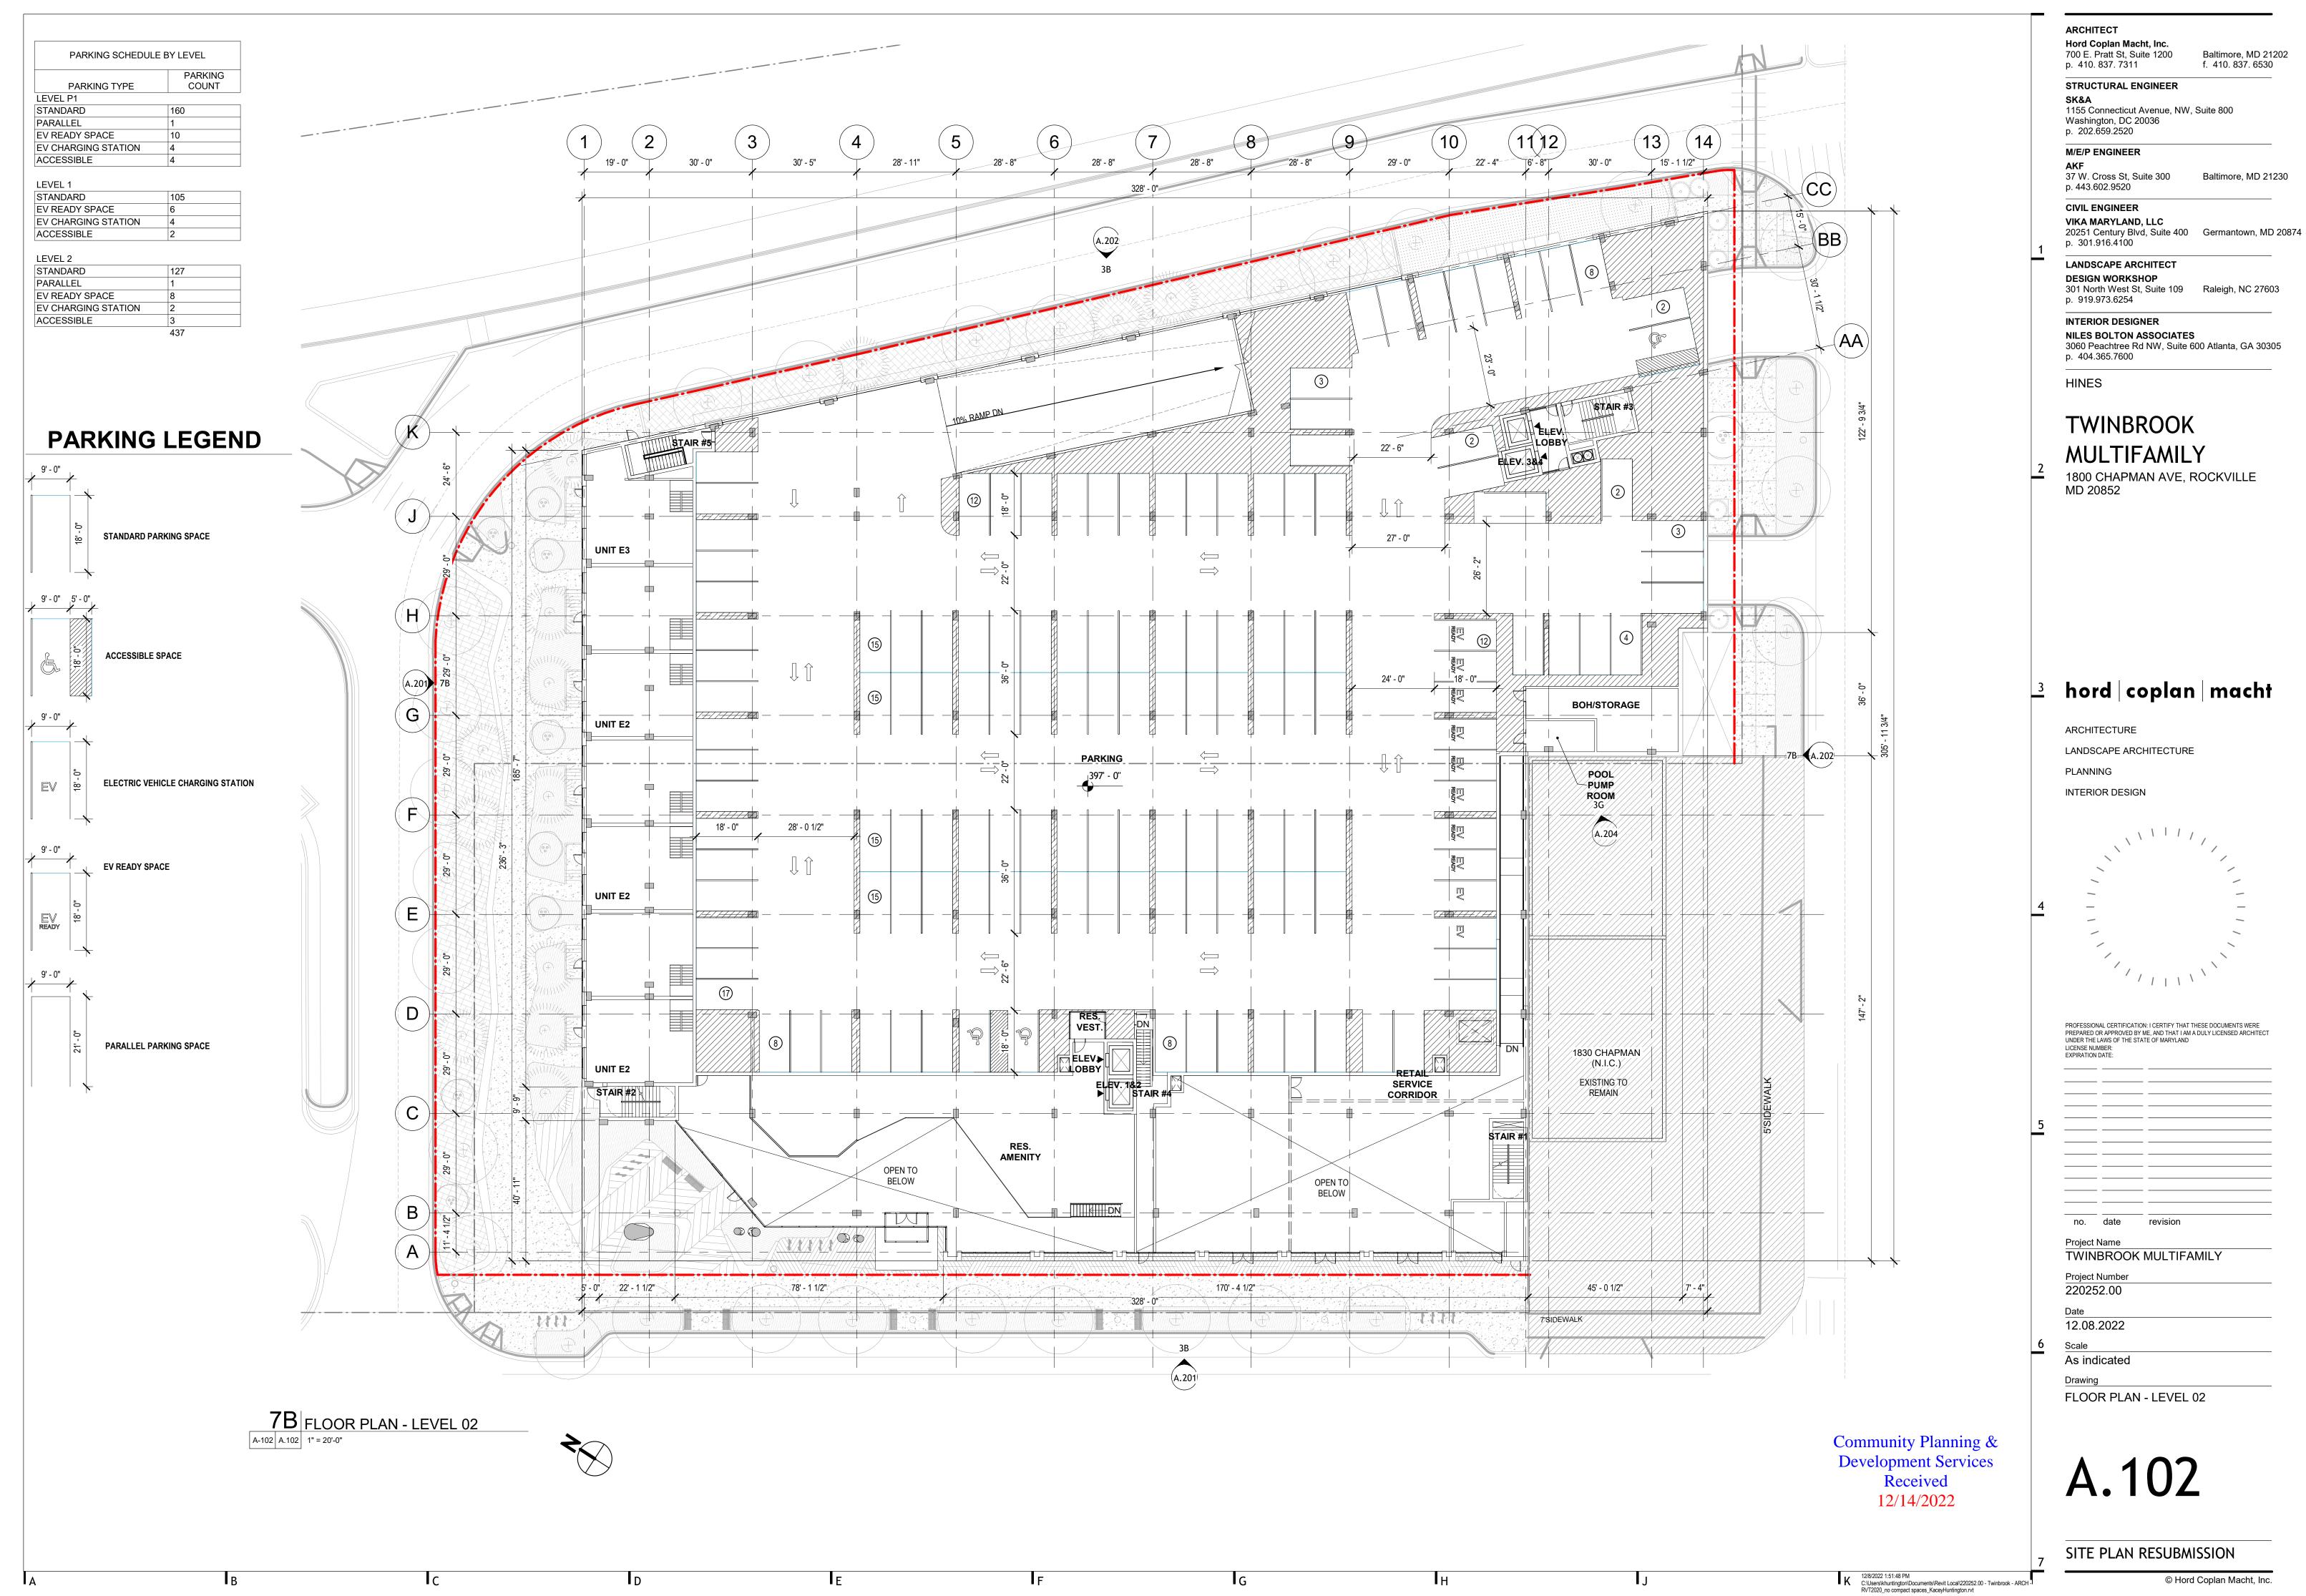
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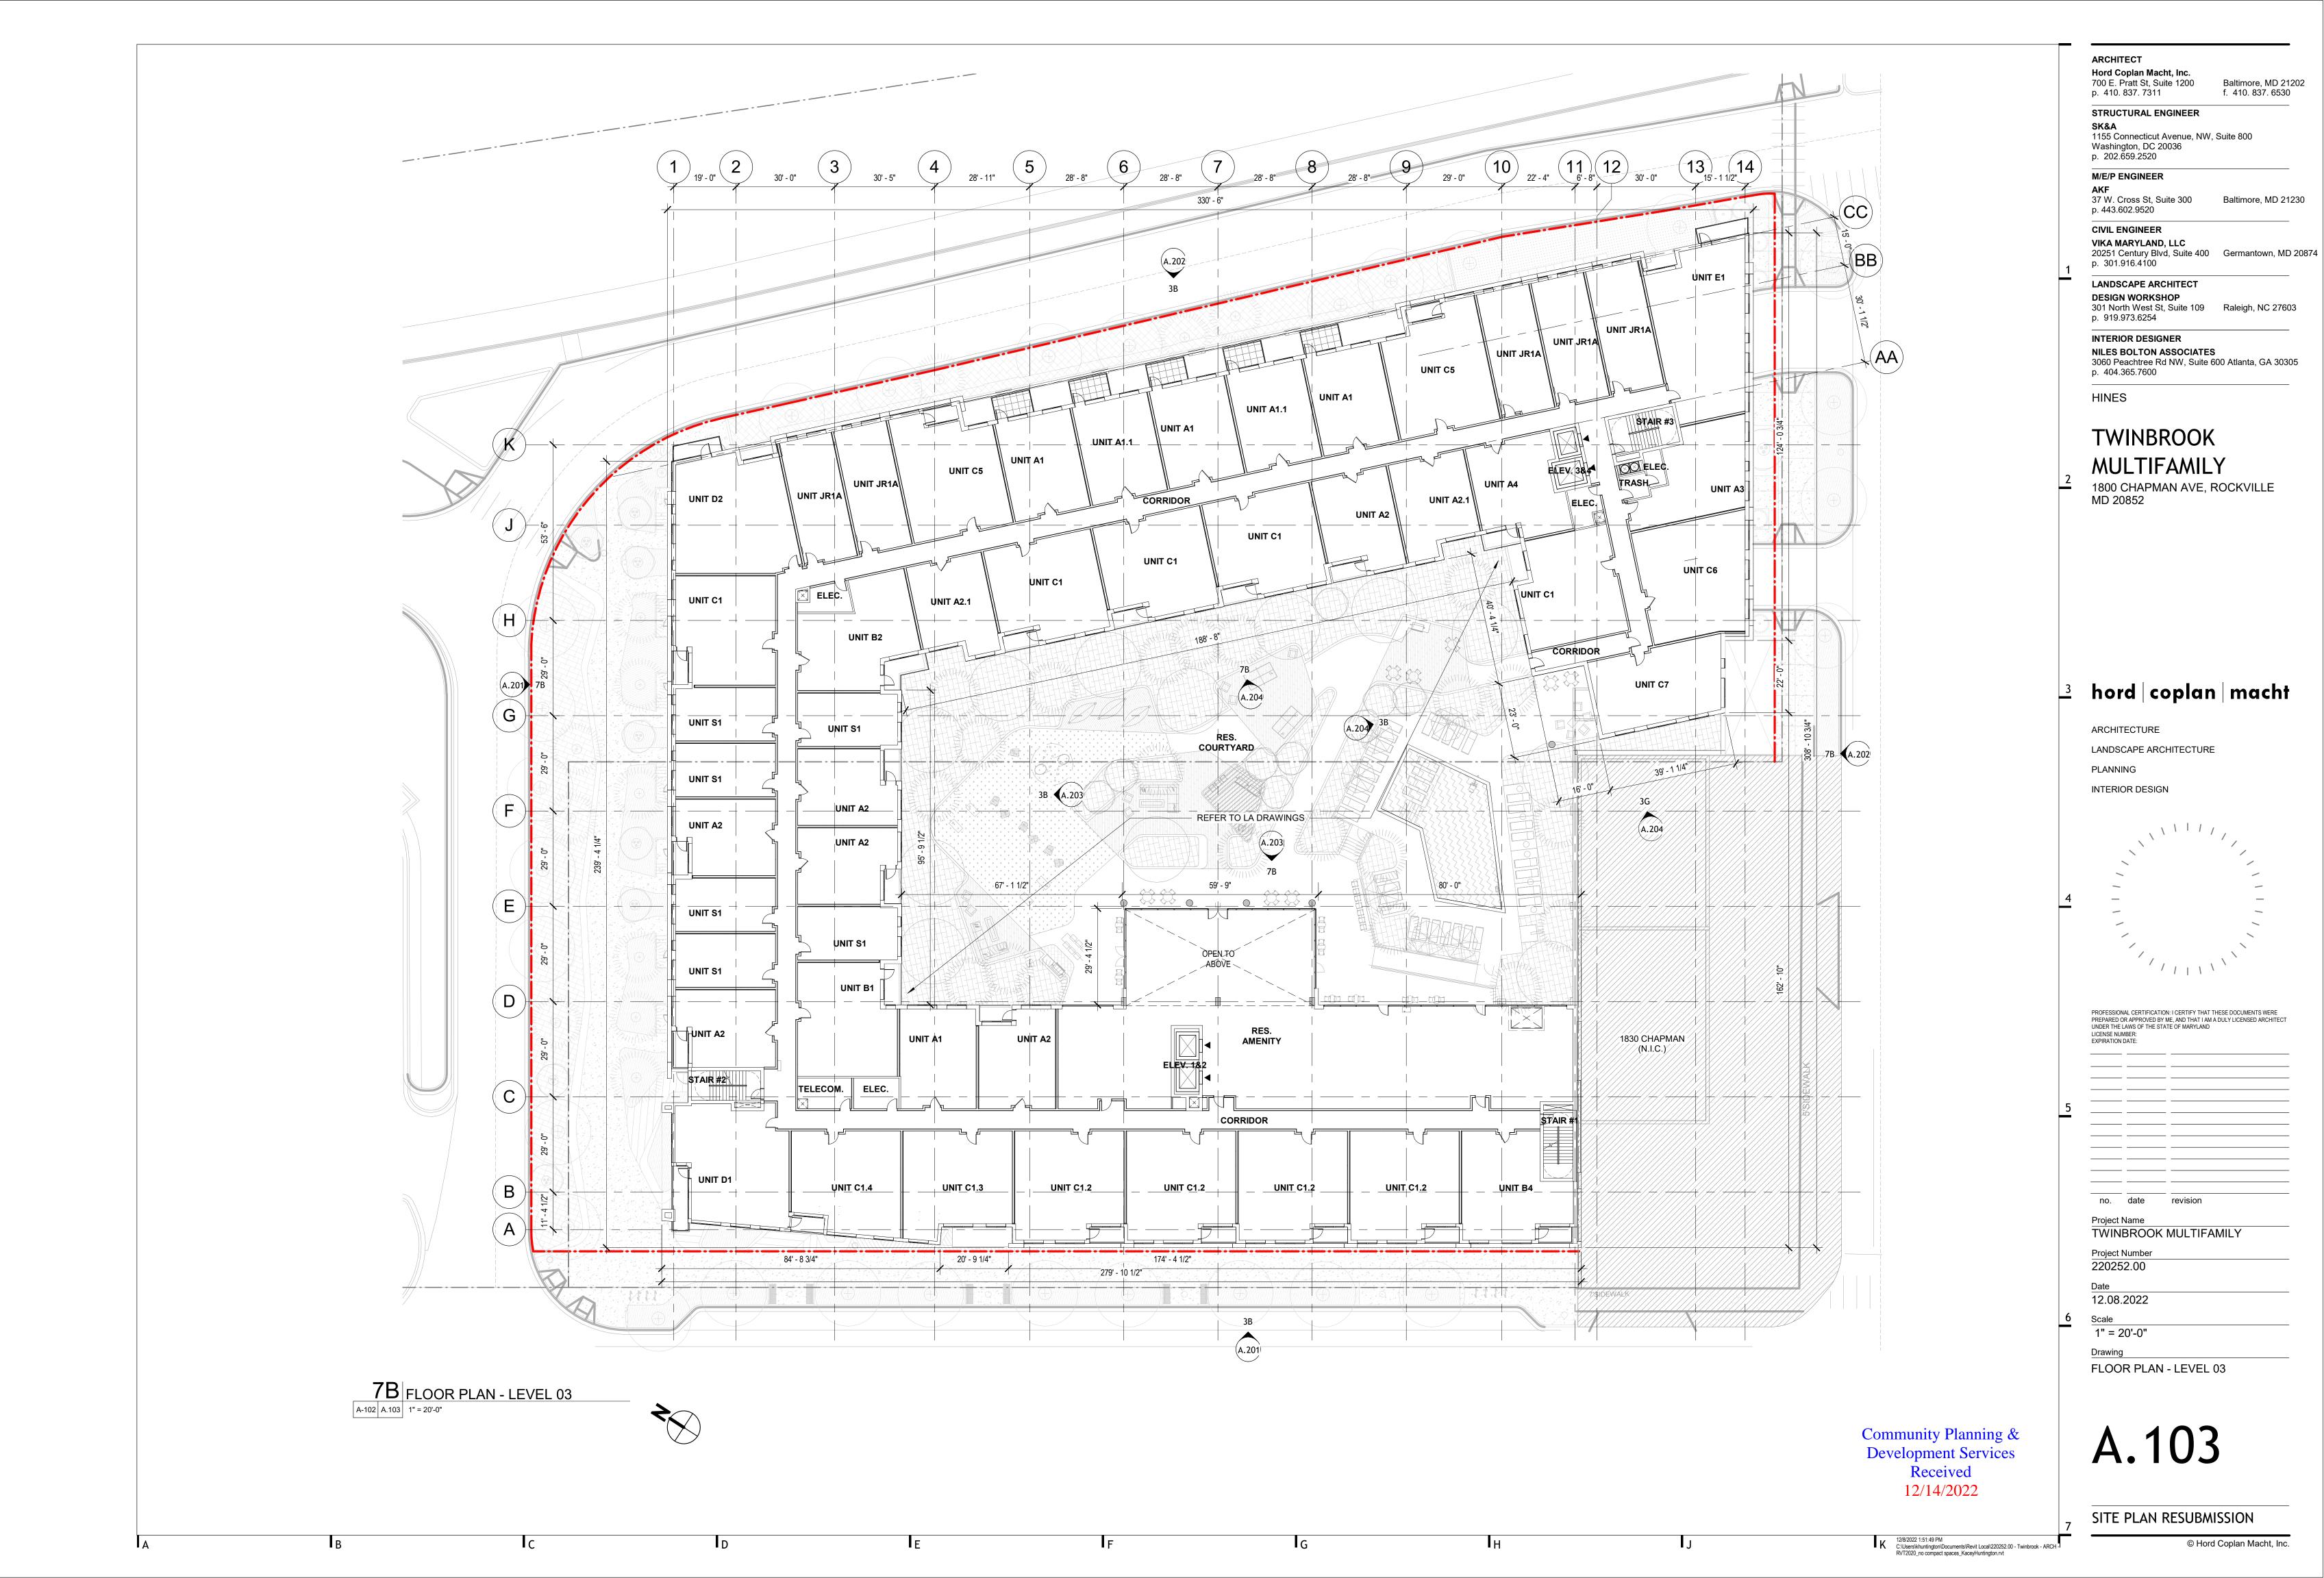
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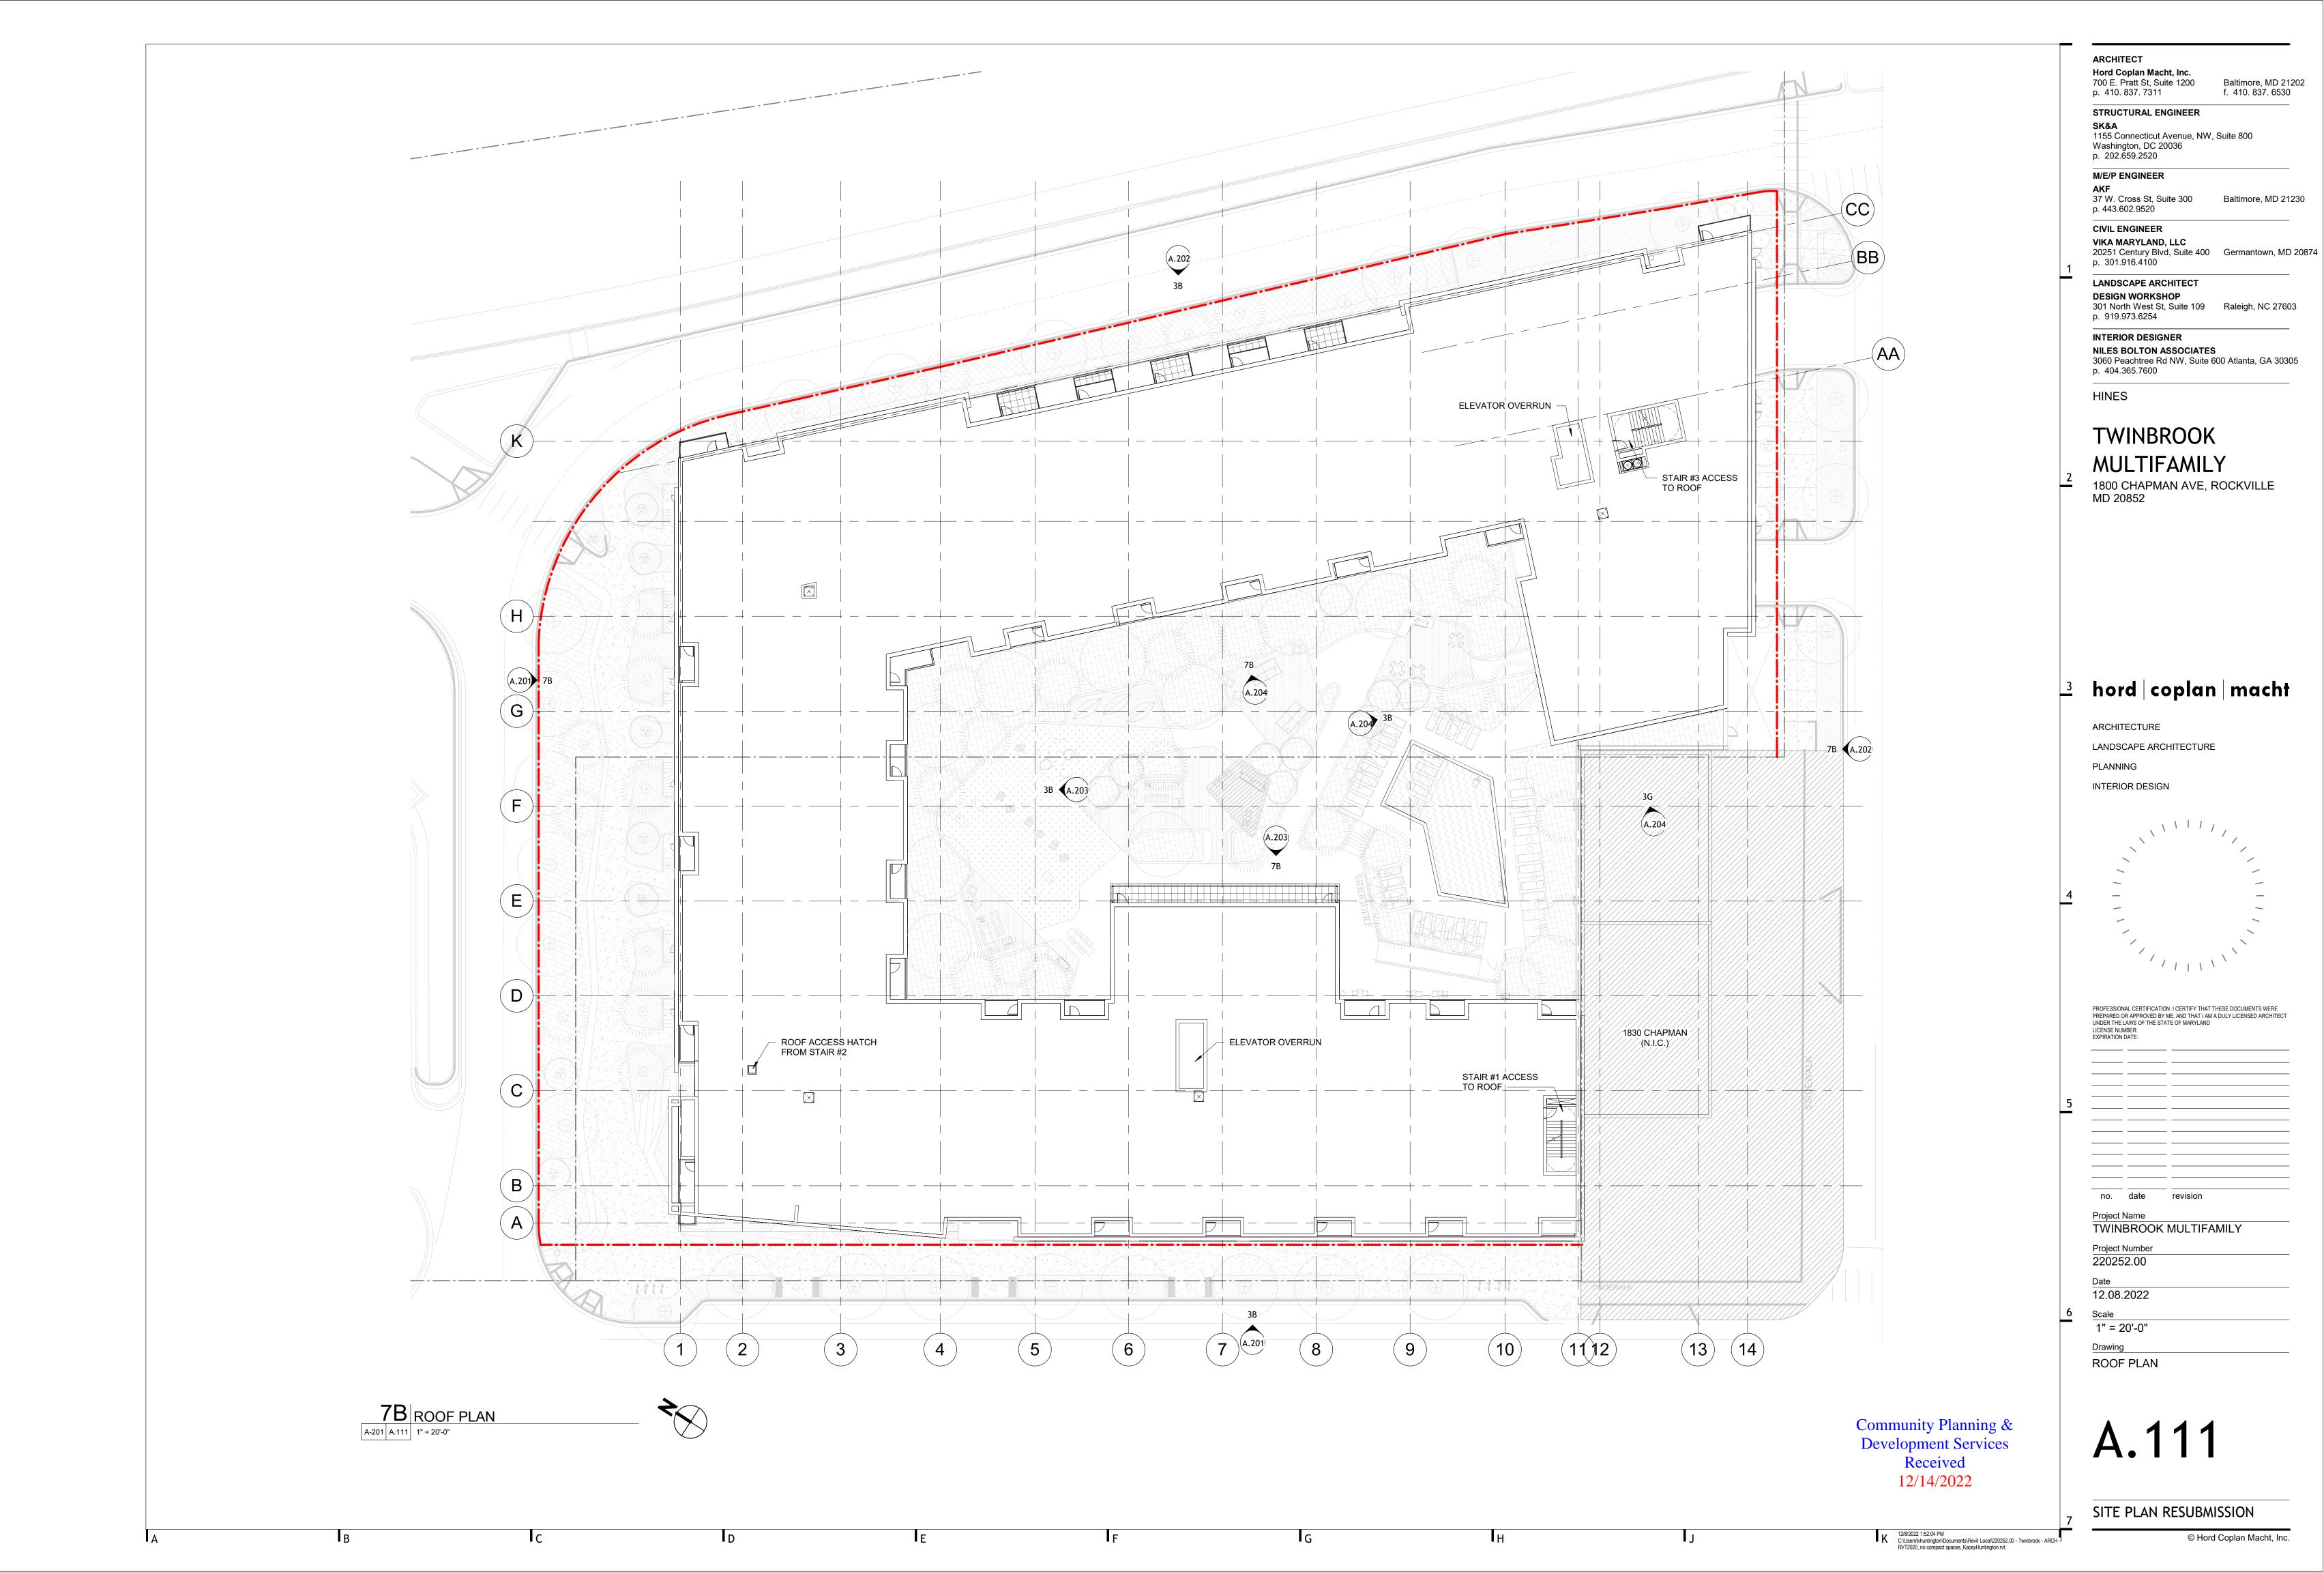













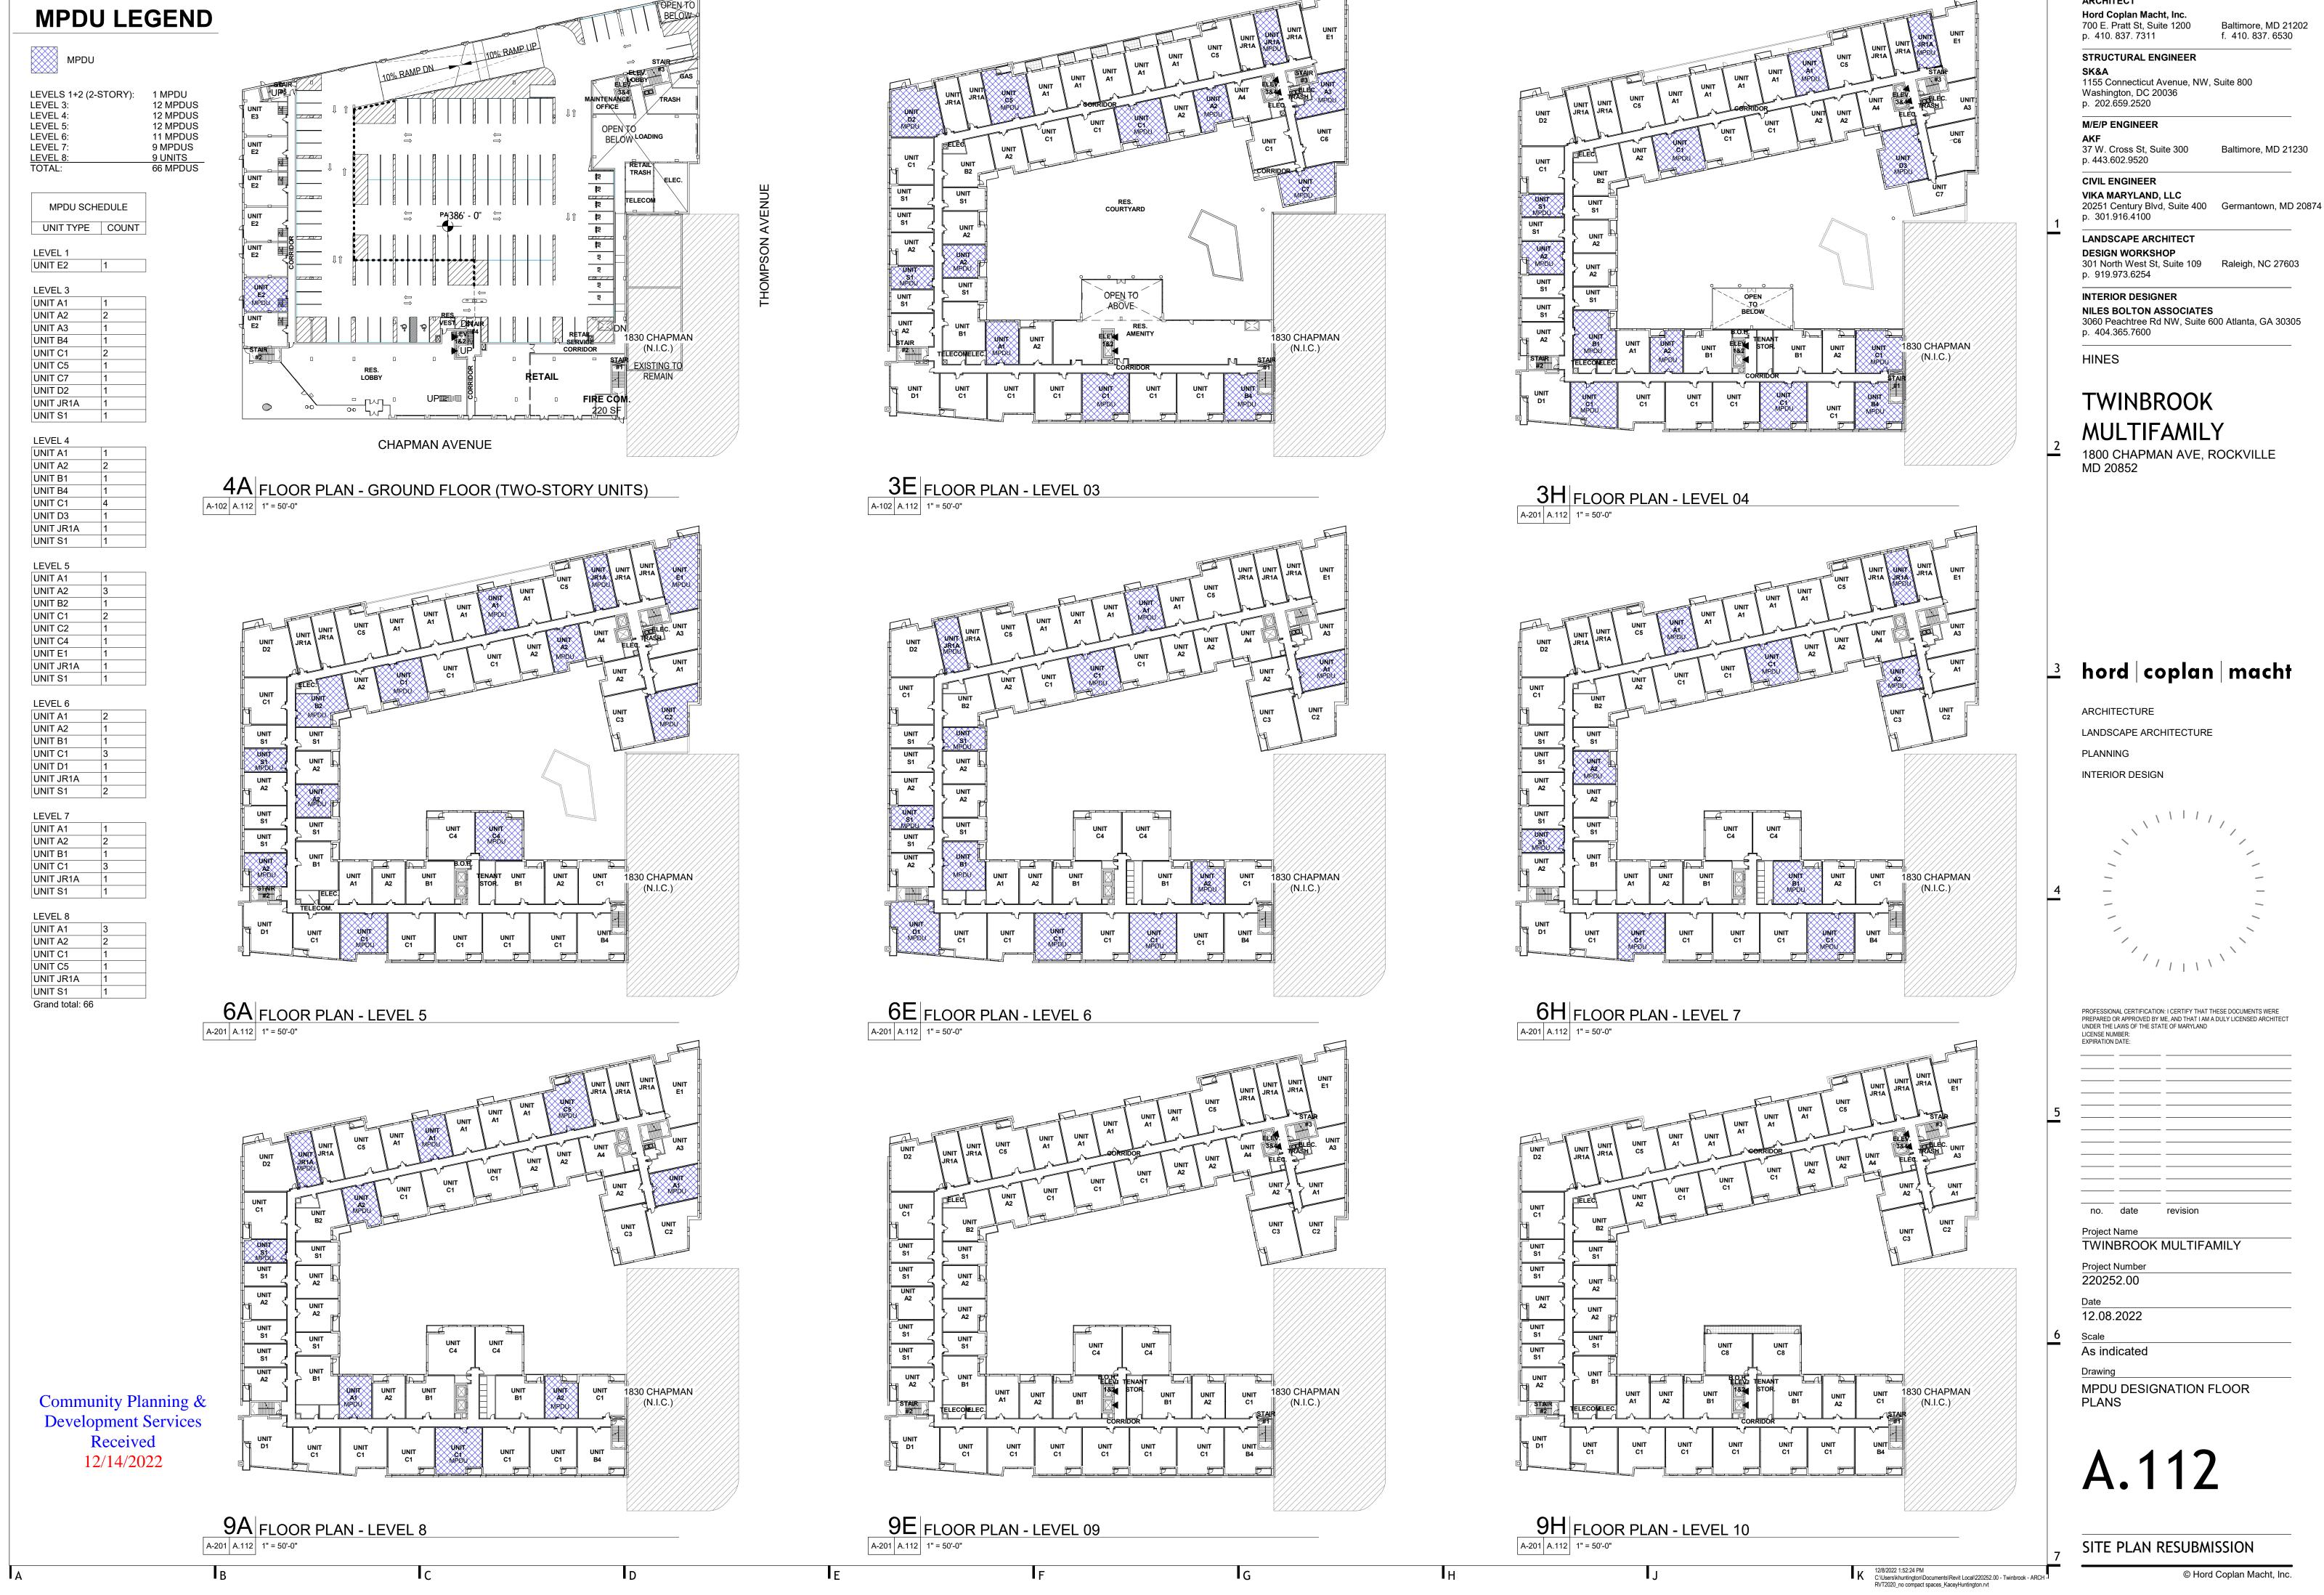

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